

#### VILLAGE OF CALEDONIA UTILITY DISTRICT MEETING AGENDA

Thursday, January 11, 2024 - 6:00 p.m.

#### Caledonia Village Hall – 5043 Chester Lane

#### THIS WILL BE AN IN-PERSON MEETING

- 1. Meeting Called to Order
- 2. Roll Call
- 3. Approval of Minutes
  - a. Utility District Regular Meeting December 6, 2023
- 4. Citizen Comments
- 5. Communications and Announcements
  - a. Racine Water Utility Agenda & Minutes
  - **b.** Utility Operator Staffing Update
- 6. Approval of O&M Bills
  - a. O&M Bills related to the Sewer, Water & Storm Water Utility District
- 7. Project Updates
  - a. Riverbend Lift Station Safety Site, Lift Station & Forcemain Upgrade
  - **b.** Annual Televising Program Sanitary Sewer
  - c. Water Impact Fee / Sewer Connection Fee Update
  - d. Central Lift Station Safety Site & Attenuation Basin
  - e. TID #4 Elevated Storage Tank & Adams Road Watermain
  - **f.** Hoods Creek Aldebaran Brushing Project
  - g. Turtle Creek Restoration

#### 8. Action Items

- a. 6243 Charles Street Utility Bill Concern
- Approval Onsite Civil Engineering Infrastructure Plan & Storm Water Management Plan Waters Edge Place – CCM-Caledonia LLC
- c. Acceptance of Infrastructure Corona Drive Extension
- **d.** Authorization of Signatures Water and Sewer Assessment Agreement 13108 4 Mile Road
- e. Authorization of Signatures Water and Sewer Assessment Agreement 13510 4 Mile Road
- **f.** Authorization of Signatures Water and Sewer Assessment Agreement 13010 4 Mile Road
- 9. Adjournment

- 1. Meeting Called to Order The Regular Meeting of the Village of Caledonia Utility District was held on Wednesday, December 6, 2023. The meeting was called to order by President Howard Stacey at 6:00 pm.
- **2. Roll Call** Those present were President Howard Stacey, Commissioners Robert Kaplan, Dave Ruffalo and Trustee Lee Wishau. Commissioner John Strack was excused. Also, present was Public Services Director Anthony Bunkelman.

#### 3. Approval of Minutes

**a.** Upon a motion by Trustee Wishau and seconded by Commissioner Kaplan, the Commission approved the minutes from the Utility District's previous regular meeting held November 1, 2023. **Motion carried.** 

#### 4. Citizens Comments

DRAFT

#### 5. Communications & Announcements

#### a. Racine Water Utility Agenda & Minutes

The Commission looked over the agenda and minutes from the November 21<sup>st</sup> meeting of the Racine Water Utility. Director Bunkelman gave a brief summary of the meeting.

#### b. Racine Wastewater Utility Agenda & Minutes

The Commission looked over the agenda and minutes from the November 21<sup>st</sup> meeting of the Racine Wastewater Utility. Director Bunkelman gave a brief summary of the meeting.

#### c. Utility Operator Staffing Update

Director Bunkelman indicated that the open position would need to be reposted because the last posting did not provide any viable candidates.

#### 6. Approval of O&M Bills

- **a.** Trustee Wishau moved to approve the Sewer Utility Invoices in the amount of \$442,467.74 from the December 1 invoice list. Seconded by Commissioner Kaplan. **Motion carried.**
- **b.** Trustee Wishau moved to approve the Water Utility Invoices in the amount of \$26,673.31 from the December 1 invoice list. Seconded by Commissioner Kaplan. **Motion carried.**
- **c.** Trustee Wishau moved to approve the Storm Water Utility Invoices in the amount of \$8,006.67 from the December 1 invoice list. Seconded by Commissioner Ruffalo. **Motion carried.**

#### 7. Project Updates

#### a. Construction Contract Status

The last contract is being wrapped up with this meeting.

#### b. Riverbend Lift Station Safety Site, Lift Station & Forcemain Upgrade

Looking to wrap up the Facility Plan to have it reviewed by staff. Once reviewed will submit it to DNR and look to schedule a Public Hearing.

#### c. Annual Televising Program – Sanitary Sewer

Continue to perform repairs that staff can perform.



#### d. Water Impact Fee / Sewer Connection Fee Update

The Committee of the Whole, at their November 28 meeting, approved and recommended forwarding the REU Ratio table to the Village Board for Approval. This item will be on the Village Board on December 12.

#### e. Central Lift Station Safety Site & Attenuation Basin

The Committee of the Whole, at their November 28 meeting, approved and recommended forwarding to the Village Board the Sole Source purchase of the Air Release Valves for the forcemain. This item will be on the Village Board on December 12.

#### f. TID #4 Elevated Storage Tank & Adams Road Watermain

Elevated Tank Plans at DNR for approval. Awaiting any comments. Plan Commission and Village Board approved the entitlement process for the Elevated Storage Tank. Final Design meeting to be held soon.

#### g. Hoods Creek - Aldebaran Brushing Project

Contractor has expended the budget for 2023 and will continue work in 2024.

#### h. Douglas Avenue – OMG Ditch Project

Final work for restoration completed the first week of November. Change Order #3 on agenda for miscellaneous quantities. The Final Pay Request has been received and Final Acceptance is recommended.

#### i. Turtle Creek Restoration

Southern Wisconsin Appraisal meeting with owners to discuss easement acquisition. Will be working with Great Lake Tree to remove some of the trees that are creating issues in the Klema Ditch. Discussed 2 properties with Southern Wisconsin Appraisal for various items. Will be providing appropriate easement documents when created.

#### **Action Items**

a. Authorization of Signatures – Professional Services Contract – Information & **Education Program for Meeting the Department of Natural Resources Storm** Water Permit Requirements – Root Pike WIN

Trustee Wishau moved to approve the Professional Services Contract with Root Pike Watershed Initiative Network for the Respect our Waters Storm Water Education and Outreach Program for 2 years with the not to exceed amount of \$9,088 and authorize the Public Services Director to execute the Contract. Seconded by Commissioner Kaplan. **Motion carried.** 

#### b. Change Order #3 – STH 32 Stream Restoration Project



Commissioner Kaplan moved to approve Change Order #3 in the amount of \$9,653.00 for the STH 32 Stream Restoration Project. Seconded by Commissioner Ruffalo. **Motion carried.** 

#### c. Final Acceptance – STH 32 Stream Restoration Project

Commissioner Kaplan moved to recommend Final Acceptance of the STH 32 Stream Restoration Project. Seconded by Commissioner Ruffalo. **Motion carried.** 

#### d. Utility Acceptance - Caledonia Corporate Park - TI Investors of Caledonia LLC

Commissioner Kaplan moved to accept the Sanitary Sewer, Sanitary Sewer Laterals, Watermain, Water Laterals, and Storm Water Facilities for the Caledonia Corporate Park subject to a satisfactory review of the Asbuilts and the execution of the Storm Water Pond Easements. Seconded by Trustee Wishau. **Motion carried.** 

#### e. January 2024 Commission Meeting

The January 2024 meeting of the Caledonia Utility District will be held Thursday January 11, 2024.

#### f. Discussion – 6243 Charles Street – Utility Bill Concern

The owner of 6243 Charles Street, Jody Kardos, was present and stated that she does not feel that she is being billed equitably. The property at 6243 Charles Street is billed for 2 units of sewer.

Ms. Kardos incorporated living space in her recently constructed, detached garage. Ms. Kardos was informed prior to constructing the garage that if she created living space in the garage, she was going to be charged for 2 units of sewer. Ms. Kardos is now petitioning the Commission to reduce her sewer units back to 1. Ms. Kardos referred to the Ordinance having a range of 1 to 2 units for a Garage. She also feels that the Garage reference in the Ordinance is for a commercial business.

Director Bunkelman indicated that he was aware of 2 instances of owners creating living space in their garages.

The Commission requested that information be pulled from Workhorse for similar situations and then they will consider it at the January Commission meeting.

#### 9. Adjournment

Upon a motion by Trustee Wishau and seconded by Commissioner Kaplan, the Commission moved to adjourn the regular meeting at 6:55 pm. Motion carried.

> Respectively submitted, Anthony A. Bunkelman P.E. Public Services Director

> > DRAFT



#### **City of Racine**

City Hall 730 Washington Ave. Racine, WI 53403 www.cityofracine.org

# Meeting Agenda Waterworks Commission

Tuesday, December 5, 2023 4:30 PM City Hall, Room 207

**ROLL CALL** 

1113-23 Subject: Proposal from CDM Smith for 2024 Lead Service Line

Replacement Contract Management

**Fiscal Note:** Cost of the proposal is \$222,092.

Attachments: LSL assistance proposal cdm smith revised 20231130

#### Adjournment

If you are disabled and have accessibility needs or need information interpreted for you, please contact the Water Utility Administration Office at 262.636.9181, at least 48 hours prior to this meeting.



#### **City of Racine**

City Hall 730 Washington Ave. Racine, WI 53403 www.cityofracine.org

#### **Meeting Minutes - Draft**

#### **Waterworks Commission**

Tuesday, December 5, 2023 4:30 PM City Hall, Room 207

**ROLL CALL** 

PRESENT: 7 - Natalia Taft, John Tate II, Stacy Sheppard, Cory Mason, Paul Vornholt,

Mollie Jones and Terry McCarthy

**EXCUSED:** 1 - Jason Meekma

1113-23 Subject: Proposal from CDM Smith for 2024 Lead Service Line

Replacement Contract Management

**Fiscal Note:** Cost of the proposal is \$222,092, which includes optional services for outreach and loan administration tasks.

The Water Utility Director presented an amended proposal from CDM Smith, which detailed the community outreach portion of the project as being an optional task. Discussion had occurred at the November 21, 2023, Commission meeting regarding using local non-profit agencies to engage with the community to initiate the objectives of replacing lead laterals compatible with the City's Lead Service Line (LSL) replacement ordinance. It was the opinion of the City Attorney's Office that outreach in this context is not solely specific to non-profit partners, but is an encouraged task amongst multiple involved parties.

A motion was made by Mayor Mason, seconded by President Tate II, with motion to Approve the proposal submitted by CDM Smith, with the understanding that a Request for Proposal (RFP) be solicited for 2025 LSL replacement management.

There being no further business to address, the meeting was adjourned at 5:03 p.m.

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				Report dates: 6/1/2023-2/29/2024	Jan 05, 2024 11:43Al		
FUND	Vendor	Vendor Name	Invoice Number	Description	Invoice Date	Net Invoice Amount	GL Account and Title
ACH - SUPERFLEET							
Water Utility Fund	1730	ACH - SUPERFLEET	EJ974 112023	NOVEMBER FUEL CHARGES IN	11/20/2023	.15	500-00-63200 Fuel, Oil, Fluids
Sewer Utility Fund	1730	ACH - SUPERFLEET	EJ974 112023	NOVEMBER FUEL CHARGES IN	11/20/2023	.16	501-00-63200 Fuel, Oil, Fluids
Total ACH - SUPERFL	EET:					.31	
ACH - WE ENERGIES							
Sewer Utility Fund	380	ACH - WE ENERGIES	4827568891	NOVEMBER 23 GAS & ELECTRI	12/01/2023	12,793.79	501-00-64140 Utilities
Water Utility Fund	380	ACH - WE ENERGIES	4827568891	NOVEMBER 23 GAS & ELECTRI	12/01/2023	2,090.80	500-00-64140 Utilities
Storm Water Utility Fund	380	ACH - WE ENERGIES	4827568891	NOVEMBER 23 GAS & ELECTRI	12/01/2023	263.15	502-00-64140 Utilities
Total ACH - WE ENEF	RGIES:					15,147.74	
AMERICAN WATER WORK	s						
Water Utility Fund	80	AMERICAN WATER WORKS	7002163326	2024-2025 MEMBERSHIP DUES	10/24/2023	275.00	500-16200-000 Prepaid Expenses
Total AMERICAN WA	TER WORK	KS:				275.00	
BATTERIES PLUS							
Sewer Utility Fund	176	BATTERIES PLUS	P69173129	RIVERBEND GENERATOR BATT	01/03/2024	464.50	501-00-64250 Equipment Repairs & Maintenanc
Total BATTERIES PLU	JS:					464.50	
BUY RIGHT, INC.							
Water Utility Fund	273	BUY RIGHT, INC.	14873-420724	OIL; WAASHER FLUID	12/22/2023	76.11	500-00-63200 Fuel, Oil, Fluids
Sewer Utility Fund	273	BUY RIGHT, INC.	14873-420724	OIL; WASHER FLUID	12/22/2023	76.11	501-00-63200 Fuel, Oil, Fluids
Total BUY RIGHT, INC	D.:					152.22	
CORE & MAIN LP							
Water Utility Fund	405	CORE & MAIN LP	T969613	MAINT. & REPAIRS	11/22/2023	16,269.90	500-00-64240 Building Repairs & Maintenance
Total CORE & MAIN L	.P:					16,269.90	
FOTH INFRASTRUCTURE	& ENVIRO	, LLC					
Storm Water Utility Fund	666	FOTH INFRASTRUCTURE & EN	87330	STH 32 STREAM RESTORATION	12/05/2023	1,071.07	502-00-65154 HWY 32 Stream Restoration
Storm Water Utility Fund		FOTH INFRASTRUCTURE & EN	87331	WESTVIEW VILLAGE STORMWA	12/05/2023		502-00-65156 Westview Village Storm
Storm Water Utility Fund		FOTH INFRASTRUCTURE & EN	87332	TURTLE CREEK RESTORATION	12/05/2023		502-00-65155 Turtle Creek Restoration
Sewer Utility Fund		FOTH INFRASTRUCTURE & EN	87337	RIVER BEND LIFT STATION SAF	12/05/2023		501-18725-000 CIP-Riverbend Safety Site
Sewer Utility Fund	666	FOTH INFRASTRUCTURE & EN	87340	HOODS CREEK ATTENUATION	12/05/2023	1,215.20	501-18736-000 CIP-Hoods Creek Attenuation

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FUND	Vendor	Vendor Name	Invoice Number	Description	Invoice Date	Net Invoice Amount	GL Account and Title
Vater Utility Fund	666	FOTH INFRASTRUCTURE & EN	87344	WASHINGTON MEADOWS WAT	12/05/2023	858.60	500-18737-107 CIP - WASHINGTON MEADOWS
Vater Utility Fund	666	FOTH INFRASTRUCTURE & EN	87347	CUD GENERAL ENGINEERING	12/05/2023	1,127.80	500-00-61340 Engineering Design Charges
Sewer Utility Fund	666	FOTH INFRASTRUCTURE & EN	87347	CUD GENERAL ENGINEERING	12/05/2023	2,513.84	501-00-61340 Engineering Design Charges
Vater Utility Fund	666	FOTH INFRASTRUCTURE & EN	87348	SUNDANCE HEIGHTS WATER M	12/05/2023	13,831.62	500-18738-107 CIP - SUNDANCE HEIGHTS
Vater Utility Fund	666	FOTH INFRASTRUCTURE & EN	87349	UCMR5 SAMPLING	12/05/2023	128.80	500-00-61340 Engineering Design Charges
Sewer Utility Fund	666	FOTH INFRASTRUCTURE & EN	87790	NOV 23; HOODS CREEK ATTEN	12/26/2023	644.00	501-18736-000 CIP-Hoods Creek Attenuation
Vater Utility Fund	666	FOTH INFRASTRUCTURE & EN	87801	WASHINGTON MEADOWS WAT	12/26/2023	3,748.00	500-18737-107 CIP - WASHINGTON MEADOWS
Sewer Utility Fund	666	FOTH INFRASTRUCTURE & EN	87807	NOV 30 GENERAL ENGINEERIN	12/26/2023	1,330.19	501-00-61340 Engineering Design Charges
Vater Utility Fund	666	FOTH INFRASTRUCTURE & EN	87807	NOV 30 GENERAL ENGINEERIN	12/26/2023	2,486.19	500-00-61340 Engineering Design Charges
Vater Utility Fund	666	FOTH INFRASTRUCTURE & EN	87811	SUNDANCE HEIGHTS WATER M	12/26/2023	14,496.11	500-18738-107 CIP - SUNDANCE HEIGHTS
Storm Water Utility Fund	666	FOTH INFRASTRUCTURE & EN	87819	HWY 32 STREAM RESTORATIO	12/26/2023	680.80	502-00-65154 HWY 32 Stream Restoration
Storm Water Utility Fund	666	FOTH INFRASTRUCTURE & EN	87820	NOV 23; WESTVIEW VILLAGE S	12/26/2023	829.96	502-00-65156 Westview Village Storm
Storm Water Utility Fund	666	FOTH INFRASTRUCTURE & EN	87821	NOV 23 STORM SEWER GPS L	12/26/2023	276.00	502-00-65152 GIS Update
Total FOTH INFRAST	RUCTURE	& ENVIRO, LLC:				47,522.78	
& F EXCAVATING							
Vater Utility Fund	687	G & F EXCAVATING	35985	REPAIR WATER MAIN BREAK @	12/04/2023	6,997.50	500-00-64240 Building Repairs & Maintenance
Vater Utility Fund	687	G & F EXCAVATING	35997	WATERMAIN REPAIR @ N. GRE	12/19/2023	4,010.00	500-00-64240 Building Repairs & Maintenance
Vater Utility Fund	687	G & F EXCAVATING	36000	REPLACE FIRE HYDRANT; 4 1/2	12/27/2023	3,301.50	500-00-64240 Building Repairs & Maintenance
later Utility Fund	687	G & F EXCAVATING	36001	REPAIR WATER MAIN VALVES	12/29/2023	3,823.75	500-00-64240 Building Repairs & Maintenance
Total G & F EXCAVA	TING:					18,132.75	
GREAT LAKES TREE & C	LEARING L	LC					
Storm Water Utility Fund	748	GREAT LAKES TREE & CLEARI	0000682	TREE REMOVAL - YORKTOWN	10/19/2023	4,400.00	502-00-64260 Grounds Repairs & Maintenance
Storm Water Utility Fund	748	GREAT LAKES TREE & CLEARI	0000683	REMOVAL OF TREES - HOODS	10/19/2023	24,800.00	502-00-65153 Hood Creek Brushing
Total GREAT LAKES	TREE & CI	EARING LLC:				29,200.00	
GROVE FARMS							
Vater Utility Fund	762	GROVE FARMS	2727	STRAW BALES (10)	12/07/2023	50.00	500-00-64240 Building Repairs & Maintenance
Total GROVE FARMS	S:					50.00	
OHNSON CONTROLS SE	CURITY S	OLUTIONS					
Vater Utility Fund	969	JOHNSON CONTROLS SECURI	39619042	Q1-24; SECURITY SOLUTIONS	12/09/2023	311.92	500-00-64150 Communication Services
Sewer Utility Fund	000	JOHNSON CONTROLS SECURI	39619042	Q1-24; SECURITY SOLUTIONS	12/09/2023		501-00-64150 Communication Services

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FUND	Vendor	Vendor Name	Invoice Number	Description	Invoice Date	Net Invoice Amount	GL Account and Title
Total JOHNSON C	ONTROLS SI	ECURITY SOLUTIONS:				623.83	
ORTENDICK HARDWA	ARE .						
ewer Utility Fund	1096	KORTENDICK HARDWARE	162572	CRESTVIEW GEN ROOM HEAT	12/20/2023	8.99	501-00-64250 Equipment Repairs & Maintenanc
Total KORTENDIC	K HARDWAR	RE:				8.99	
EE MECHANICAL, INC							
ater Utility Fund	1159	LEE MECHANICAL, INC.	26720	CALEDONIA 8" WM 4 MILE	12/12/2023	3,200.00	500-00-64240 Building Repairs & Maintenance
ater Utility Fund	1159	LEE MECHANICAL, INC.	27071	CALEDONIA 8" METER REPLAC	12/18/2023	9,007.00	500-00-64240 Building Repairs & Maintenance
Total LEE MECHA	NICAL, INC.:					12,207.00	
GHTHOUSE COMMUN	IICATIONS						
ater Utility Fund	1170	LIGHTHOUSE COMMUNICATIO	1020124	Q4-23; SEWER DISTRICT MAILI	01/02/2024	3,778.56	500-00-64040 Postage & Shipping
ewer Utility Fund	1170	LIGHTHOUSE COMMUNICATIO	1020124	Q4-23; SEWER DISTRICT MAILI	01/02/2024	3,778.56	501-00-64040 Postage & Shipping
ater Utility Fund	1170	LIGHTHOUSE COMMUNICATIO	1020124	Q4-23; SEWER DISTRICT MAILI	01/02/2024	1,276.24	500-00-64030 Office Supplies
ewer Utility Fund	1170	LIGHTHOUSE COMMUNICATIO	1020124	Q4-23; SEWER DISTRICT MAILI	01/02/2024	1,276.24	501-00-64030 Office Supplies
Total LIGHTHOUS	E COMMUNI	CATIONS:				10,109.60	
LWAUKEE METROPO	LITAN SEW	AGE DISTRICT					
ewer Utility Fund	1338	MILWAUKEE METROPOLITAN S	CC3-23	2023 CAPITAL CHARGES; MMS	12/26/2023	42,430.00	501-00-62550 Sewer Treatment Charges
Total MILWAUKEE	METROPOL	ITAN SEWAGE DISTRICT:				42,430.00	
OODYS INVESTORS	SERVICE						
ater Utility Fund	1351	MOODYS INVESTORS SERVICE	O0420991	2022-2023 BOND SURVEILLANC	10/27/2023	500.00	500-00-61310 Banking/Financial Charges
ater Utility Fund	1351	MOODYS INVESTORS SERVICE	P0420988	2022-2023 ANNUAL SURVEILLA	10/27/2023	500.00	500-00-61310 Banking/Financial Charges
Total MOODYS IN	/ESTORS SE	ERVICE:				1,000.00	
AK CREEK WATER UT	TILITY						
ater Utility Fund		OAK CREEK WATER UTILITY	4TH QTR WAT	Q4-2023; WATER 11100 S CHICA	12/15/2023	99,328.60	500-00-62550 Purchased Water
ater Utility Fund	1423	OAK CREEK WATER UTILITY	4TH QTR WAT	Q4-2023; WATER 11100 S CHICA	12/15/2023	19,239.37	500-00-64180 Public Fire Protection
ater Utility Fund	1423	OAK CREEK WATER UTILITY	4TH QTR WAT	WATER 10014 DUANE CT	12/15/2023	10,505.32	500-00-62550 Purchased Water
ater Utility Fund	1423	OAK CREEK WATER UTILITY	4TH QTR WAT	Q4-23; WATER - NICHOLSON	12/15/2023	7,154.43	500-00-62550 Purchased Water
ater Utility Fund	1423	OAK CREEK WATER UTILITY	5273	WATER TESTS	11/28/2023	365.00	500-00-62560 Water Sampling and Testing
ater Utility Fund	1423	OAK CREEK WATER UTILITY	5281	WATER TESTS	12/07/2023	365.00	500-00-62560 Water Sampling and Testing

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**FUND** Vendor Invoice Number Description Invoice Date GL Account and Title Vendor Name Net Invoice Amount Water Utility Fund 1423 OAK CREEK WATER UTILITY 5290 WATER SAMPLES 12/22/2023 365.00 500-00-62560 Water Sampling and Testing Total OAK CREEK WATER UTILITY: 137,322.72 **RACINE WATER & WASTEWATER UTILITIES** Water Utility Fund 1574 RACINE WATER & WASTEWATE 2641396 Q4-23; WATER 01/01/2024 358,388.22 500-00-62550 Purchased Water Water Utility Fund 1574 RACINE WATER & WASTEWATE 2641396 Q4-23; WATER 01/01/2024 49.250.00 500-00-64180 Public Fire Protection Total RACINE WATER & WASTEWATER UTILITIES: 407.638.22 RESTOREMORE INC Sewer Utility Fund 9267 RESTOREMORE INC 4646 SEWER BACKUP - RIGHT OF W 09/01/2023 2.327.50 501-00-61000 Professional Services 2.327.50 Total RESTOREMORE INC: **ROOT PIKE WIN** Storm Water Utility Fund 1697 ROOT PIKE WIN 111-324 TRAINING; ROOT-PIKE WATERS 12/11/2023 4.544.00 502-00-62102 MS4 - PUBLIC EDUCATION Total ROOT PIKE WIN: 4,544.00 SHERWIN INDUSTRIES Water Utility Fund 1795 SHERWIN INDUSTRIES SC051614 COLD PATCH 12/22/2023 1,266.72 500-00-64240 Building Repairs & Maintenance Total SHERWIN INDUSTRIES: 1,266.72 SJE, INC. Sewer Utility Fund 1119 SJE, INC CD99506076 VOLUTE SPACER - HOODS CRE 12/07/2023 4,887.80 501-00-64250 Equipment Repairs & Maintenanc Total SJE, INC .: 4,887.80 SOUTHERN WISCONSIN APPRAISAL Storm Water Utility Fund 1824 SOUTHERN WISCONSIN APPR CALCREEK-09 APPRAISAL TURTLE CREEK 502-00-65155 Turtle Creek Restoration 12/13/2023 Storm Water Utility Fund 1824 SOUTHERN WISCONSIN APPR CALCREEK-12 APPRAISAL TURTLE CREEK 12/13/2023 2.250.00 502-00-65155 Turtle Creek Restoration Storm Water Utility Fund 1824 SOUTHERN WISCONSIN APPR CALCREEK-13 APPRAISAL TURTLE CREEK 12/13/2023 2,250.00 502-00-65155 Turtle Creek Restoration Storm Water Utility Fund 1824 SOUTHERN WISCONSIN APPR CALCREEK-15 APPRAISAL TURTLE CREEK 12/13/2023 2,250.00 502-00-65155 Turtle Creek Restoration Total SOUTHERN WISCONSIN APPRAISAL: 9,000.00 ULINE Water Utility Fund 2030 ULINE 172286664 **GLOVES & COVERALLS** 618.65 500-00-64070 Work Supplies 12/18/2023

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FUND	Vendor	Vendor Name	Invoice Number	Description	Invoice Date	Net Invoice Amount	GL Account and Title
Sewer Utility Fund	2030	ULINE	172286664	GLOVES & COVERALLS	12/18/2023	618.64	501-00-64070 Work Supplies
Total ULINE:						1,237.29	
WISCONSIN RURAL WATI	ER ASSOC						
Water Utility Fund	2185	WISCONSIN RURAL WATER AS	S6180	MEMBERSHIP RENEWAL	01/01/2024	615.00	500-00-51320 Memberships/Dues
Total WISCONSIN RI	JRAL WATE	ER ASSOC:				615.00	
WORKHORSE SOFTWAR	E						
Nater Utility Fund	2201	WORKHORSE SOFTWARE	5655	UTILITY BILLING SOFTWARE S	12/01/2023	675.00	500-00-64300 IT Maintenance & Subscriptions
Sewer Utility Fund	2201	WORKHORSE SOFTWARE	5655	UTILITY BILLING SOFTWARE S	12/01/2023	675.00	501-00-64300 IT Maintenance & Subscriptions
Total WORKHORSE	SOFTWAR	E:				1,350.00	
Grand Totals:						763,783.87	

#### PAYMENT TOTALS BY FUND

TOTALS	\$763,783.87
WATER UTILITY FUND	\$640,281.86
STORMWATER UTILITY FUND	\$ 47,122.98
SEWER UITILITY FUND	\$ 76,379.03

# CALEDONIA UTILITY DISTRICT PROJECT SUMMARY WORKSHEET

#### Riverbend Drive Lift Station Safety Site & Forcemain Upgrade

• Looking to wrap up Facility Plan to have it reviewed by staff. Once reviewed will submit to DNR and look to schedule a Public Hearing.

#### **Annual Televising Program – Sanitary Sewer**

• Continue to perform repairs that staff can perform.

#### **Water Impact Fee / Sewer Connection Fee Update**

• The Village Board adopted the REU Table at the December 12 meeting.

#### Central Lift Station Safety Site & Attenuation Basin

• Air Release Valves have been ordered. Initial timeline is 12 to 18 weeks. Pump #1 has been pulled and being rebuilt. Pump #1 is able to be repaired in Madison and does not need to be shipped to Kansas City. Impeller wear ring and Volute wear ring are good. Needs new bearing frame assembly. Will be able to restore the pump to factory tolerances. Pump #1 to be completed soon and then will pull Pump #2.

#### TID #4 Elevated Storage Tank & Adams Road Watermain

• Elevated Storage Tank Plans at DNR for approval. Awaiting any comments.

#### CALEDONIA UTILITY DISTRICT STORM WATER PROJECTS PROJECT SUMMARY WORKSHEET

#### **Hoods Creek - Aldebaran Brushing Project**

• Contractor will be contacted to begin work again in 2024.

#### **Turtle Creek Restoration**

- Southern Wisconsin Appraisal meeting with owners to discuss easements.
- Provided Easement Documents for 4 Properties
- Will be working with Great Lake Tree to remove some of the trees that are creating issues in the Klema Ditch.

#### **MEMORANDUM**

authory Bunkelnar

DATE: Friday, January 5, 2024

TO: Caledonia Utility District

FROM: Anthony A. Bunkelman P.E.

**Public Services Director** 

**RE:** 6243 Charles Street – Utility Bill Concern

#### BACKGROUND INFORMATION

At the December Utility District Commission meeting, Ms. Jody Kardos was present and raised a concern about how she was being charged for Sanitary Sewer on her property. Ms. Kardos recently built a detached garage and as part of the construction of the garage, living space was incorporated into the garage. Prior to the construction of the garage, Ms. Kardos was informed that she would be charged for 2 units of sewer due to the living space. Ms. Kardos is now contesting that she should not be charged with 2 units of sewer.

Director Bunkelman provided a couple of examples of where he believe that the same scenario exists and was directed to review the billing system to find out if there are similar situations and how those situations are billed. The Commission wants to be consistent and not set precedence.

After reviewing the billing system there are 3 situations that are similar to Ms. Kardos where the property is charged multiple units of sewer. These are 5509 Middle Road, 2714 4 ½ Mile Road, and 9519 Caddy Lane. A 4<sup>th</sup> situation will be updated shortly pending the release of an occupancy permit at 6651 Charles Street.

After review of the billing system and similar situations billed identical, it is recommended that there are no changes made to the utility bill at 6243 Charles Street.

#### RECOMMENDATION

Move to recommend that no changes are made to the Utility Bill at 6243 Charles Street reducing the number of sewer units.

#### **MEMORANDUM**

DATE: Thursday, January 4, 2024

**TO:** Caledonia Utility District

FROM: Anthony A. Bunkelman P.E.

**Public Services Director** 

**RE:** Approval - Onsite Civil Engineering Infrastructure Improvement

Plan & Storm Water Management Plan - Waters Edge Place - CCM-

authory Bunkelnar

Caledonia LLC

#### BACKGROUND INFORMATION

Aaron Koch P.E. of Pinnacle Engineering Group has prepared an Onsite Civil Engineering Infrastructure Plan & a Storm Water Management Plan for Waters Edge Place, a 93-unit condominium development, utilizing townhouses and villas located on the East side of Waters Edge Drive. In addition, there will be a Clubhouse which provides a pool and court sports.

The Onsite Civil Engineering Infrastructure Plan details and designs the Public Sanitary Sewer, Private Watermain, Private Storm Water facilities, and Private Road Improvements for the creation of the 93 units.

The proposed Sanitary Sewer will serve the 93 units. There will be 2 branches of Sanitary Sewer extended (1 East & 1 West) off of the existing Sanitary Sewer that bisects the site. Each building will have its own sanitary lateral serving the units in the building.

The proposed Watermain within the site will be private and will provide a lateral to each building. The Watermain will also be for fire protection (internal & with hydrants). The private Watermain will be served from a Master Meter Vault at Waters Edge Drive connected to the existing Public Watermain on Waters Edge Drive.

The proposed Storm Sewer within the site will drain to 1 of the 2 proposed Storm Water Ponds that ultimately discharge to Lake Michigan.

The site is required to provide Storm Water Management by Ordinance. This development falls under Base Storm Water Regulations. Base Storm Water Regulations are that the 100 yr. post development peak runoff must be reduced to or below the 10 yr. predevelopment peak runoff and the 10 yr. post development peak runoff must be reduced to or below the 2 yr. predevelopment peak runoff. The site must also achieve 40% Total Suspended Solids removal as it is a redevelopment project.

The Storm Water Management Plan meets the Ordinance by meeting the required reductions in peak flow (37.6 cfs peak 100 vs 42 cfs peak 10 and 11.4 cfs peak 10 vs 22.3 cfs peak 2) and the required TSS removal (44.6% TSS vs 40% TSS).

The Onsite Civil Engineering Infrastructure Plan has been submitted to and reviewed by the Village Engineer, the Public Services Director, and the Utility District Consultant. The Storm Water Management Plan has been submitted to and reviewed by the Public Services Director. The Onsite Civil Engineering Infrastructure Plan and the Storm Water Management Plan are in conformance with the Ordinance and are ready for Utility District Approval.

Included in this packet are the Onsite Civil Engineering Infrastructure Plan and the Storm Water Management Plan Summary.

#### RECOMMENDATION

Move to approve the Onsite Civil Engineering Infrastructure Plan and the Storm Water Management Plan for Waters Edge Place subject to the following:

- 1) The Sanitary Sewer Extension is approved by the Racine Wastewater Utility.
- 2) The Design Engineer determines that the plans approved by the Caledonia Utility District and Engineering Department are technically adequate and are stamped by the Design Engineer.
- 3) The Final Condominium Plat is submitted and approved by the Village of Caledonia.
- 4) Legal Descriptions and Exhibits for the required Sanitary Sewer Easements, Master Meter Vault Easement, and Storm Water Pond Easements are provided, and the Developer executes the necessary documents.
- 5) The applicant obtains all necessary permits from the Village, County and State prior to performing the project.



# STORMWATER MANAGEMENT PLAN

#### **Waters Edge**

Caledonia, Wisconsin



PEG Project Number: 2145.01-WI

October 5, 2023









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#### **APPENDICIES**

#### APPENDIX 1 - MAPS

Vicinity Map

#### **APPENDIX 2 - PRE-DEVELOPMENT CONDITIONS INFORMATION**

- Hydrology Exhibit Existing Conditions
- Hydrographs

#### APPENDIX 3 - POST-DEVELOPMENT CONDITIONS (RATE ATTENUATION)

- Hydrology Exhibit Proposed Conditions
- Hydrographs

#### APPENDIX 4 - POST-DEVELOPMENT CONDITIONS (WATER QUALITY)

• WinSLAMM Modeling Input Data & Output Computations

APPENDIX 5 - SOIL BORINGS

#### Questions and comments can be directed to:

Aaron E. Koch, P.E. Sr. Project Manager | Principal Phone: 262.754.8888 | Fax: 262.754.8850 aekoch@pinnacle-engr.com



#### INTRODUCTION

The proposed project consists of a removal of an old school campus and construction of a new multi-family complex. The Village of Caledonia and the Wisconsin DNR have jurisdiction on the site with regards to stormwater goals. PEG has prepared a plan which will meet these goals.

#### **DESIGN CRITERIA**

Village of Caledonia...... Title 9 Chapter 2– also follows DNR regulations

Water Quantity: The Village of Caledonia requires the 100-ver post development peak

<u>Water Quantity</u>: The Village of Caledonia requires the 100-yer post development peak discharge to not exceed the 10-year predevelopment peak runoff discharge. The post-development runoff discharges for storms up to and including the 10-year shall not exceed the 2-year predevelopment peak discharge. The 1-year proposed storm event must also be kept at or below existing conditions for the 1-year storm per NR 151.

<u>Water Quality</u>: Since the site is a redevelopment, the minimum Village and DNR requirements are to remove 40% of the total suspended solids (TSS) load on an average annual basis from the runoff from the site.

<u>Infiltration:</u> Infiltration is required for sites containing soils suitable for infiltration. In this case, the soil is not suitable for infiltration. Per NR 151, the site is exempt from the need to do infiltration and thus infiltration is not provided as part of this plan.

<u>Protective Areas:</u> The DNR requires a protective area for impervious surfaces that drain into the wetland. The wetland report identifies this wetland as requiring a 10' protective area.

#### **EXISTING CONDITIONS**

The site previously contained a school campus which has already been demolished. The school campus condition is still used though as the existing condition of the site since the demolition work was completed recently as part of this project. All of the drainage is ultimately tributary to Lake Michigan. Some of the site previously drained directly to the lake while a large portion drains through a storm sewer line along the north property line. This storm sewer line was determined to be collapsed and non functional and a new storm sewer line was installed in the same general area to convey runoff from the site to the Lake. The geotechnical report shows a variety of near surface materials which also include some fill, but all of the native soils underneath are clay, which will be modeled as soil group C.

#### POST-DEVELOPMENT CONDITIONS

It is proposed to develop the site as multi family with multiple buildings, driveways, parking, open space and stormwater facilities. Drainage from the new development will be mostly direct two one of the two ponds for treatment. A smaller area is undetained. All runoff will

still be tributary to Lake Michigan through the new storm sewer pipe. Note that the southerly undetained area will be directed to the south instead of the northeasterly pipe. There is a clearly defined path for this water which appears to be a navigable steam. There is already a significant amount of other water that currently flows through this low area. Therefore the addition of a small amount of additional runoff through this flow path is not expected to have any adverse impacts to the property.

The ponds will provide detention and water quality in the form of TSS removal. Ponds will have outlets that will connect to the new storm pipes that discharge to Lake Michigan. Ponds will also have overflows for emergency events.

#### **ANALYSIS METHODS**

HydroCAD® (Version 10.00) software has been used to analyze stormwater characteristics for this stormwater management plan. HydroCAD uses the accepted TR-55 methodology for determining peak discharge runoff rates. Rainfall depths for the 1-year, 2-year, 10-year and 100-year storm events are 2.35, 2.67, 3.77, and 5.92 inches in accordance with NOAA Atlas 14 and Village requirements. MSE3 24-hour rainfall distributions are used.

TSS reduction characteristics for the proposed water quality facilities were determined using WinSLAMM® (Version 10.4) Source Loading and Management Model.

Note that the east pond volume below 604.25 is not included in the HydroCAD model in the event that the pond bottom is clogged or has not drained down.

#### **SUMMARY OF RESULTS**

#### Existing Conditions

Note that the existing conditions include a small area of Water's Edge Drive that drains onto the site. While this area would not have to be included in the stormwater goals for the onsite development, for simplicity of the modeling, it has been.

#### **Existing Drainage Data**

Area	Area (ac)	CN	Tc (min)	Peak Flows 1-year (cfs)	Peak Flows 2-year (cfs)	Peak Flows 10-year (cfs)	Peak Flows 100-year (cfs)
Existing Site Discharge	16.9	80	14.0	17.2	22.3	42.0	83.4

#### **Proposed Drainage Data**

				Peak Flows	Peak Flows	Peak Flows	Peak Flows
	Area		Тс	1-year	2-year	10-year	100-year
Area	(ac)	CN	(min)	(cfs)	(cfs)	(cfs)	(cfs)
Area to North Pond	5.4	91	10.0*	12.0	14.3	22.1	37.4
Area to East Pond	9.5	81	10.0*	11.9	15.3	27.8	54.2
Undetained North	0.7	81	10.0*	0.9	1.1	2.1	4.0
Undetained South	1.3	81	10.0*	1.6	2.1	3.8	7.4
North Pond				1.2	1.3	2.6	23.5
Discharge				1.2	1.3	2.0	23.3
East Pond				3.6	4.0	5.1	6.4
Discharge				3.0	4.0	5.1	0.4
Proposed Site	16.8			6.5	7.6	11.4	37.6
Discharge	10.0			0.5	7.0	11.4	37.0

<sup>\*</sup> A Tc of 10.0 min is used as the actual computed is less than the minimum allowed of 10.0 min.

#### **Basin Data**

Pond	Basin Bottom	Normal Water	Peak W.S. Elev. 2-year	Peak W.S. Elev. 100-year	Spillway Elev.	Top of Berm Elev.
North Pond	590.0	595.0	597.1	598.7	599.0	600.0
East Pond		604.0	605.4	607.1	608.5	609.0

The modeling indicates that the pond will detain the flows so that the peak flow is maintained on the 1 and 2 year storm events. The 10-year post is detained well below the 2-yr pre, as well as the 100-yr post to the 10-yr pre.

The clogged conditions were also studied to determine overflow weir design. During a 100-year even with no outlet other than the spillway, the north pond spillway is half full (approx. 6"). The east pond does not reach the spillway. This was intentional in that overflows down the bluff would be very undesirable, so extra storage was created to minimize overflows even in extreme events.

#### Runoff Water Quality

Post-development water quality will be obtained in two ponds. Note that the two undetained areas are combined in the model for simplicity. Also note that the model incorporates the runoff from Water's Edge Road and the existing lift station within the drainage areas, though neither are required to be treated, but are included in the model for simplicity, and the water quality goals are still met.

#### **Water Quality Summary**

Area/Pond	Ponds of TSS Generated	Pounds of TSS Remaining	Percent Removal
North Pond	1925	507	73.7%
East Pond	1944	1498	22.9%
Undetained	310	310	0%
Total Site	4179	2315	44.6%

#### Infiltration

Infiltration is not required due to the lack of soils suitable for infiltration. The site contains exclusively clay native soils.

#### Protective Areas

Protective areas have been maintained on the site layout such that there are no impervious surfaces closer than 10' to the existing wetlands.

#### CONCLUSION

The stormwater management features for the development have been designed to comply with the Village and DNR regulations. This includes peak flow reduction, water quality and protective areas. The proposed ponds will serve to meet all these of these goals. Maintenance is expected to occur on a regular basis. An agreement with the Village of Caledonia will be executed to ensure this occurs.



# ONSITE CIVIL ENGINEERING INFRASTRUCTURE PLANS

OR

# WATER'S EDGE

**LEGEND** 

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—— G——— **G—**——

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POINT OF CURVATURE

POINT OF VERTICAL INTERSECTION

POINT OF TANGENCY

RADIUS

RIGHT-OF-WAY

STORM SEWER

TOP OF BANK

TOP OF CURB

TOP OF PIPE

TOP OF WALK

WATER MAIN

SANITARY SEWER

TANGENCY OF CURVE

TOP OF FOUNDATION

INTERSECTION ANGLE

TOP OF SIDEWALK

**ABBREVIATIONS** 

\_\_\_\_\_

 $\rightarrow \rightarrow \rightarrow \rightarrow$ 

\_\_\_ 749 -\_\_

 $\times (750.00)$ 

-

SANITARY SEWER MANHOLE

STORM SEWER AREA DRAIN

PRECAST FLARED END SECTION

CONCRETE HEADWALL

AIR RELEASE ASSEMBLY

VALVE BOX

FIRE HYDRANT

**BUFFALO BOX** 

SANITARY SEWER

CLEANOUT

DRAIN TILE

WATER MAIN

LIGHTING

POWER POLE

STREET SIGN

TELEPHONE LINE

SPOT ELEVATION

GAS MAIN

CONTOUR

WETLANDS

FLOODWAY

FLOODPLAIN

DITCH OR SWALE

SOIL BORING

TOPSOIL PROBE

FENCE LINE, WIRE

CONCRETE SIDEWALK

CURB AND GUTTER

DEPRESSED CURB

EASEMENT LINE

DIVERSION SWALE

HIGH WATER LEVEL (HWL)

NORMAL WATER LEVEL (NWL)

OVERFLOW RELIEF ROUTING

FENCE LINE, TEMPORARY SILT

FENCE LINE, CHAIN LINK OR IRON

FENCE LINE, WOOD OR PLASTIC

REVERSE PITCH CURB & GUTTER

C & G CURB AND GUTTER

CENTERLINE

FLOW LINE

FLOODPLAIN

**FLOODWAY** 

FRAME

INVERT

MANHOLE

DEGREE OF CURVE

**EDGE OF PAVEMENT** 

HIGH WATER LEVEL

LENGTH OF CURVE

FINISHED FLOOR

FINISHED GRADE

LONG CHORD OF CURVE

TREE WITH TRUNK SIZE

DIRECTION OF SURFACE FLOW

UTILITY CROSSING

ELECTRICAL CABLE

OVERHEAD WIRES

**ELECTRICAL TRANSFORMER** 

POWER POLE WITH LIGHT

CAUTION EXISTING UTILITIES NEARBY

STORM SEWER INLET (ROUND CASTING)


STORM SEWER INLET (RECTANGULAR CASTING)

STORM SEWER MANHOLE

# CALEDONIA, WISCONSIN

PLANS PREPARED

CARDINAL CAPITAL 901 SOUTH 70TH STREET WEST ALLIS, WISCONSIN 53214

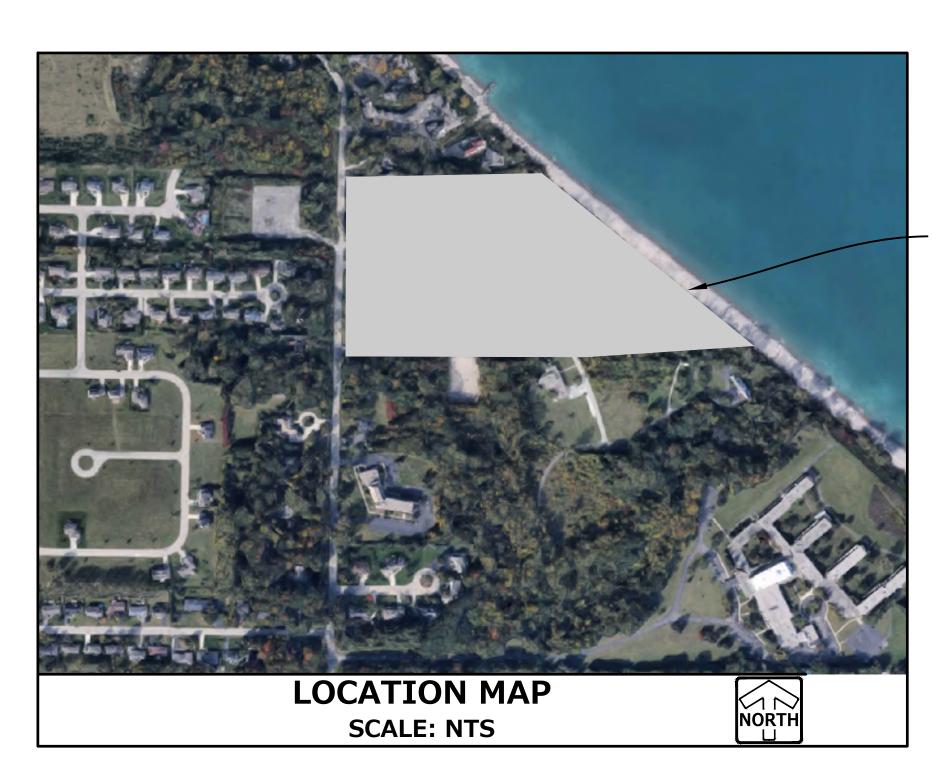

-PROJECT LOCATION

### **GENERAL NOTES**

- THE INTENTION OF THE PLANS AND SPECIFICATIONS IS TO SET FORTH PERFORMANCE AND CONSTRUCTION MATERIAL STANDARDS FOR THE PROPER EXECUTION OF WORK. ALL WORKS CONTAINED WITHIN THE PLANS AND SPECIFICATIONS SHALL BE COMPLETED IN ACCORDANCE WITH ALL REQUIREMENTS FROM LOCAL, STATE, FEDERAL OR OTHER GOVERNING AGENCY'S LAWS, REGULATIONS, JURISDICTIONAL ORDINANCES/CODES/RULES/ETC., AND THE OWNER'S DIRECTION.
- 2. A GEOTECHNICAL REPORT HAS BEEN PREPARED BY PROFESSIONAL SERVICE INDUSTRIES, INC DATED NOVEMBER 25, 2022 FOR THE SITE. THE DATA ON SUB-SURFACE SOIL CONDITIONS IS NOT INTENDED AS A REPRESENTATION OR WARRANTY OF THE CONTINUITY OF SUCH CONDITIONS BETWEEN BORINGS OR INDICATED SAMPLING LOCATIONS. IT SHALL BE EXPRESSLY UNDERSTOOD THAT OWNER WILL NOT BE RESPONSIBLE FOR ANY INTERPRETATIONS OR CONCLUSIONS DRAWN THERE FROM BY THE CONTRACTOR. DATA IS MADE AVAILABLE FOR THE CONVENIENCE OF THE CONTRACTOR. THE CONTRACTOR IS RESPONSIBLE FOR PERFORMING ANY ADDITIONAL SOILS INVESTIGATIONS THEY FEEL IS NECESSARY FOR THE PROPER EVALUATION OF THE SITE FOR PURPOSES OF PLANNING, BIDDING, OR CONSTRUCTING THE PROJECT AT NO ADDITIONAL COST TO THE OWNER.
- 3. THE CONTRACTOR IS RESPONSIBLE TO REVIEW AND UNDERSTAND ALL COMPONENTS OF THE PLANS AND SPECIFICATIONS, INCLUDING FIELD VERIFYING SOIL CONDITIONS, PRIOR TO SUBMISSION OF A BID PROPOSAL.
- 4. THE CONTRACTOR SHALL PROMPTLY REPORT ANY ERRORS OR AMBIGUITIES LEARNED AS PART OF THEIR REVIEW OF PLANS, SPECIFICATIONS, REPORTS AND FIELD INVESTIGATIONS.

THE CONTRACTOR IS SOLELY RESPONSIBLE FOR THE COMPUTATION OF QUANTITIES AND WORK REQUIRED TO COMPLETE THIS

- PROJECT. THE CONTRACTOR'S BID SHALL BE BASED ON ITS OWN COMPUTATIONS AND IN NO SUCH INSTANCE RELY ON THE ENGINEER'S ESTIMATE.

  6. QUESTIONS/CLARIFICATIONS WILL BE INTERPRETED BY ENGINEER/OWNER PRIOR TO THE AWARD OF CONTRACT.
- ENGINEER/OWNER WILL SUBMIT OFFICIAL RESPONSES IN WRITING. INTERPRETATIONS PRESENTED IN OFFICIAL RESPONSES SHALL BE BINDING ON ALL PARTIES ASSOCIATED WITH THE CONTRACT. IN NO WAY SHALL WORD-OF-MOUTH DIALOG CONSTITUTE AN OFFICIAL RESPONSE.


  7. PRIOR TO START OF WORK, CONTRACTOR SHALL BE COMPLETELY FAMILIAR WITH ALL CONDITIONS OF THE SITE, AND SHALL
- 7. PRIOR TO START OF WORK, CONTRACTOR SHALL BE COMPLETELY FAMILIAR WITH ALL CONDITIONS OF THE SITE, AND SHALL ACCOUNT FOR CONDITIONS THAT AFFECT, OR MAY AFFECT CONSTRUCTION INCLUDING, BUT NOT LIMITED TO, LIMITATIONS OF WORK ACCESS, SPACE LIMITATIONS, OVERHEAD OBSTRUCTIONS, TRAFFIC PATTERNS, LOCAL REQUIREMENTS, ADJACENT ACTIVITIES, ETC. FAILURE TO CONSIDER SITE CONDITIONS SHALL NOT BE CAUSE FOR CLAIM OF JOB EXTRAS.
- 8. COMMENCEMENT OF CONSTRUCTION SHALL EXPLICITLY CONFIRM THAT THE CONTRACTOR HAS REVIEWED THE PLANS AND SPECIFICATIONS IN ENTIRETY AND CERTIFIES THAT THEIR SUBMITTED BID PROPOSAL CONTAINS PROVISIONS TO COMPLETE THE PROJECT, WITH THE EXCEPTION OF UNFORESEEN FIELD CONDITIONS; ALL APPLICABLE PERMITS HAVE BEEN OBTAINED; AND CONTRACTOR UNDERSTANDS ALL OF THE REQUIREMENTS OF THE PROJECT.
- 9. SHOULD ANY DISCREPANCIES OR CONFLICTS IN THE PLANS OR SPECIFICATIONS BE DISCOVERED AFTER THE AWARD OF CONTRACT, ENGINEER SHALL BE NOTIFIED IN WRITING IMMEDIATELY AND CONSTRUCTION OF ITEMS AFFECTED BY THE DISCREPANCIES/CONFLICTS SHALL NOT COMMENCE, OR CONTINUE, UNTIL A WRITTEN RESPONSE FROM ENGINEER/OWNER IS DISTRIBUTED. IN THE EVENT OF A CONFLICT BETWEEN REFERENCED CODES, STANDARDS, SPECIFICATIONS AND PLANS, THE ONE ESTABLISHING THE MOST STRINGENT REQUIREMENTS SHALL BE FOLLOWED.
- 10. THE CONTRACTOR SHALL, AT ITS OWN EXPENSE, OBTAIN ALL NECESSARY PERMITS AND LICENSES TO COMPLETE THE PROJECT. OBTAINING PERMITS, OR DELAYS, IS NOT CAUSE FOR DELAY OF THE CONTRACT OR SCHEDULE. CONTRACTOR SHALL COMPLY WITH ALL PERMIT REQUIREMENTS.
- 11. THE CONTRACTOR SHALL NOTIFY ALL INTERESTED GOVERNING AGENCIES, UTILITY COMPANIES AFFECTED BY THIS CONSTRUCTION PROJECT, AND DIGGER'S HOTLINE IN ADVANCE OF CONSTRUCTION TO COMPLY WITH ALL JURISDICTIONAL ORDINANCES/CODES/RULES/ETC., PERMIT STIPULATIONS, AND OTHER APPLICABLE STANDARDS.
- 12. SAFETY IS THE SOLE RESPONSIBILITY OF THE CONTRACTOR. THE CONTRACTOR SHALL BE RESPONSIBLE TO INITIATE, INSTITUTE, ENFORCE, MAINTAIN, AND SUPERVISE ALL SAFETY PRECAUTIONS AND JOB SITE SAFETY PROGRAMS IN CONNECTION WITH THE
- 13. CONTRACTOR SHALL KEEP THE JOBSITE CLEAN AND ORDERLY AT ALL TIMES. ALL LOCATIONS OF THE SITE SHALL BE KEPT IN A WORKING MANNER SUCH THAT DEBRIS IS REMOVED CONTINUOUSLY AND ALL RESPECTIVE CONTRACTORS OPERATE UNDER

CONSTRUCTION, INSTALLATION, AND TESTING OF THE WORK ON THIS PROJECT.

GENERAL "GOOD HOUSEKEEPING."

14. THE CONTRACTOR SHALL INDEMNIFY THE OWNER, ENGINEER, AND THEIR AGENTS FROM ALL LIABILITY INVOLVED WITH THE

PINNACLE ENGINEERING GROUP
ENGINEERING I NATURAL RESOURCES I SURVEYING
20725 WATERTOWN ROAD, SUITE 100
BROOKFIELD, WI 53186
(262) 754-8888

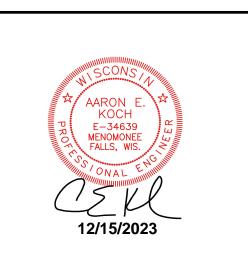

PEG PROJECT #: 2145.00



PINNACLE ENGINEERING GROUP, LLC ENGINEER'S LIMITATION

PINNACLE ENGINEERING GROUP, LLC AND THEIR CONSULTANTS DO NOT WARRANT OR GUARANTEE THE ACCURACY AND COMPLETENESS OF THE DELIVERABLES HEREIN BEYOND A REASONABLE DILIGENCE. IF ANY MISTAKES, OMISSIONS, OR DISCREPANCIES ARE FOUND TO EXIST WITHIN THE DELIVERABLES, THE ENGINEER SHALL BE PROMPTLY NOTIFIED PRIOR TO BID SO THAT HE MAY HAVE THE OPPORTUNITY TO TAKE WHATEVER STEPS NECESSARY TO RESOLVE THEM. FAILURE TO PROMPTLY NOTIFY THE ENGINEER OF SUCH CONDITIONS SHALL ABSOLVE THE ENGINEER FROM ANY RESPONSIBILITY FOR THE CONSEQUENCES OF SUCH FAILURE. ACTIONS TAKEN WITHOUT THE KNOWLEDGE AND CONSENT TO THE ENGINEER, OR IN CONTRADICTION TO THE ENGINEER'S DELIVERABLES OR RECOMMENDATIONS, SHALL BECOME THE RESPONSIBILITY NOT OF THE ENGINEER BUT OF THE PARTIES RESPONSIBLE FOR TAKING SUCH ACTION.

FURTHERMORE, PINNACLE ENGINEERING GROUP, LLC IS NOT RESPONSIBLE FOR CONSTRUCTION SAFETY OR THE MEANS AND METHODS OF CONSTRUCTION.

PROJECT TEAM CONTACTS

CIVIL ENGINEER:

AARON KOCH, P.E.

PINNACLE ENGINEERING GROUP

20725 WATERTOWN ROAD

BROOKFIELD, WI 53186

MAIN: (262) 754-8888

E-MAIL: aekoch@pinnacle-engr.com

APPLICANT:

JACK REICHL

CARDINAL CAPITAL

901 SOUTH 70TH STREET

WEST ALLIS, WI 53214

(414) 510-4256

EMAIL: jreichl@cardinalcapital.com

CO00 COVER SHEET
C100 EXISTING CONDITIONS
C101 SITE PLAN
C102 GRADING PLAN
C103 EROSION CONTROL PLAN
C104 OVERALL UTILITY PLAN
C105 SANITARY SEWER OVERALL PLAN
C106 - C-107 SANITARY SEWER PLAN & PROFILE
C108 - C110 WATER MAIN PLAN & PROFILE
C111 STORM SEWER PLAN
C112 - C114 PAVING PLAN
C115 - C117 CONSTRUCTION DETAILS SPECIFICATIONS

A Revisions

100% CONSTRUCTION DOCUMENTS

WATER'S EDGE -PHASE 1 -TOWNHOMES &

CLUBHOUSE


Water's Edge Road Caledonia, WI 53108 Date Issued: 12/12/2023 RINKA project #: 220504 Sheet Title

**COVER SHEET** 

Sheet #

C000



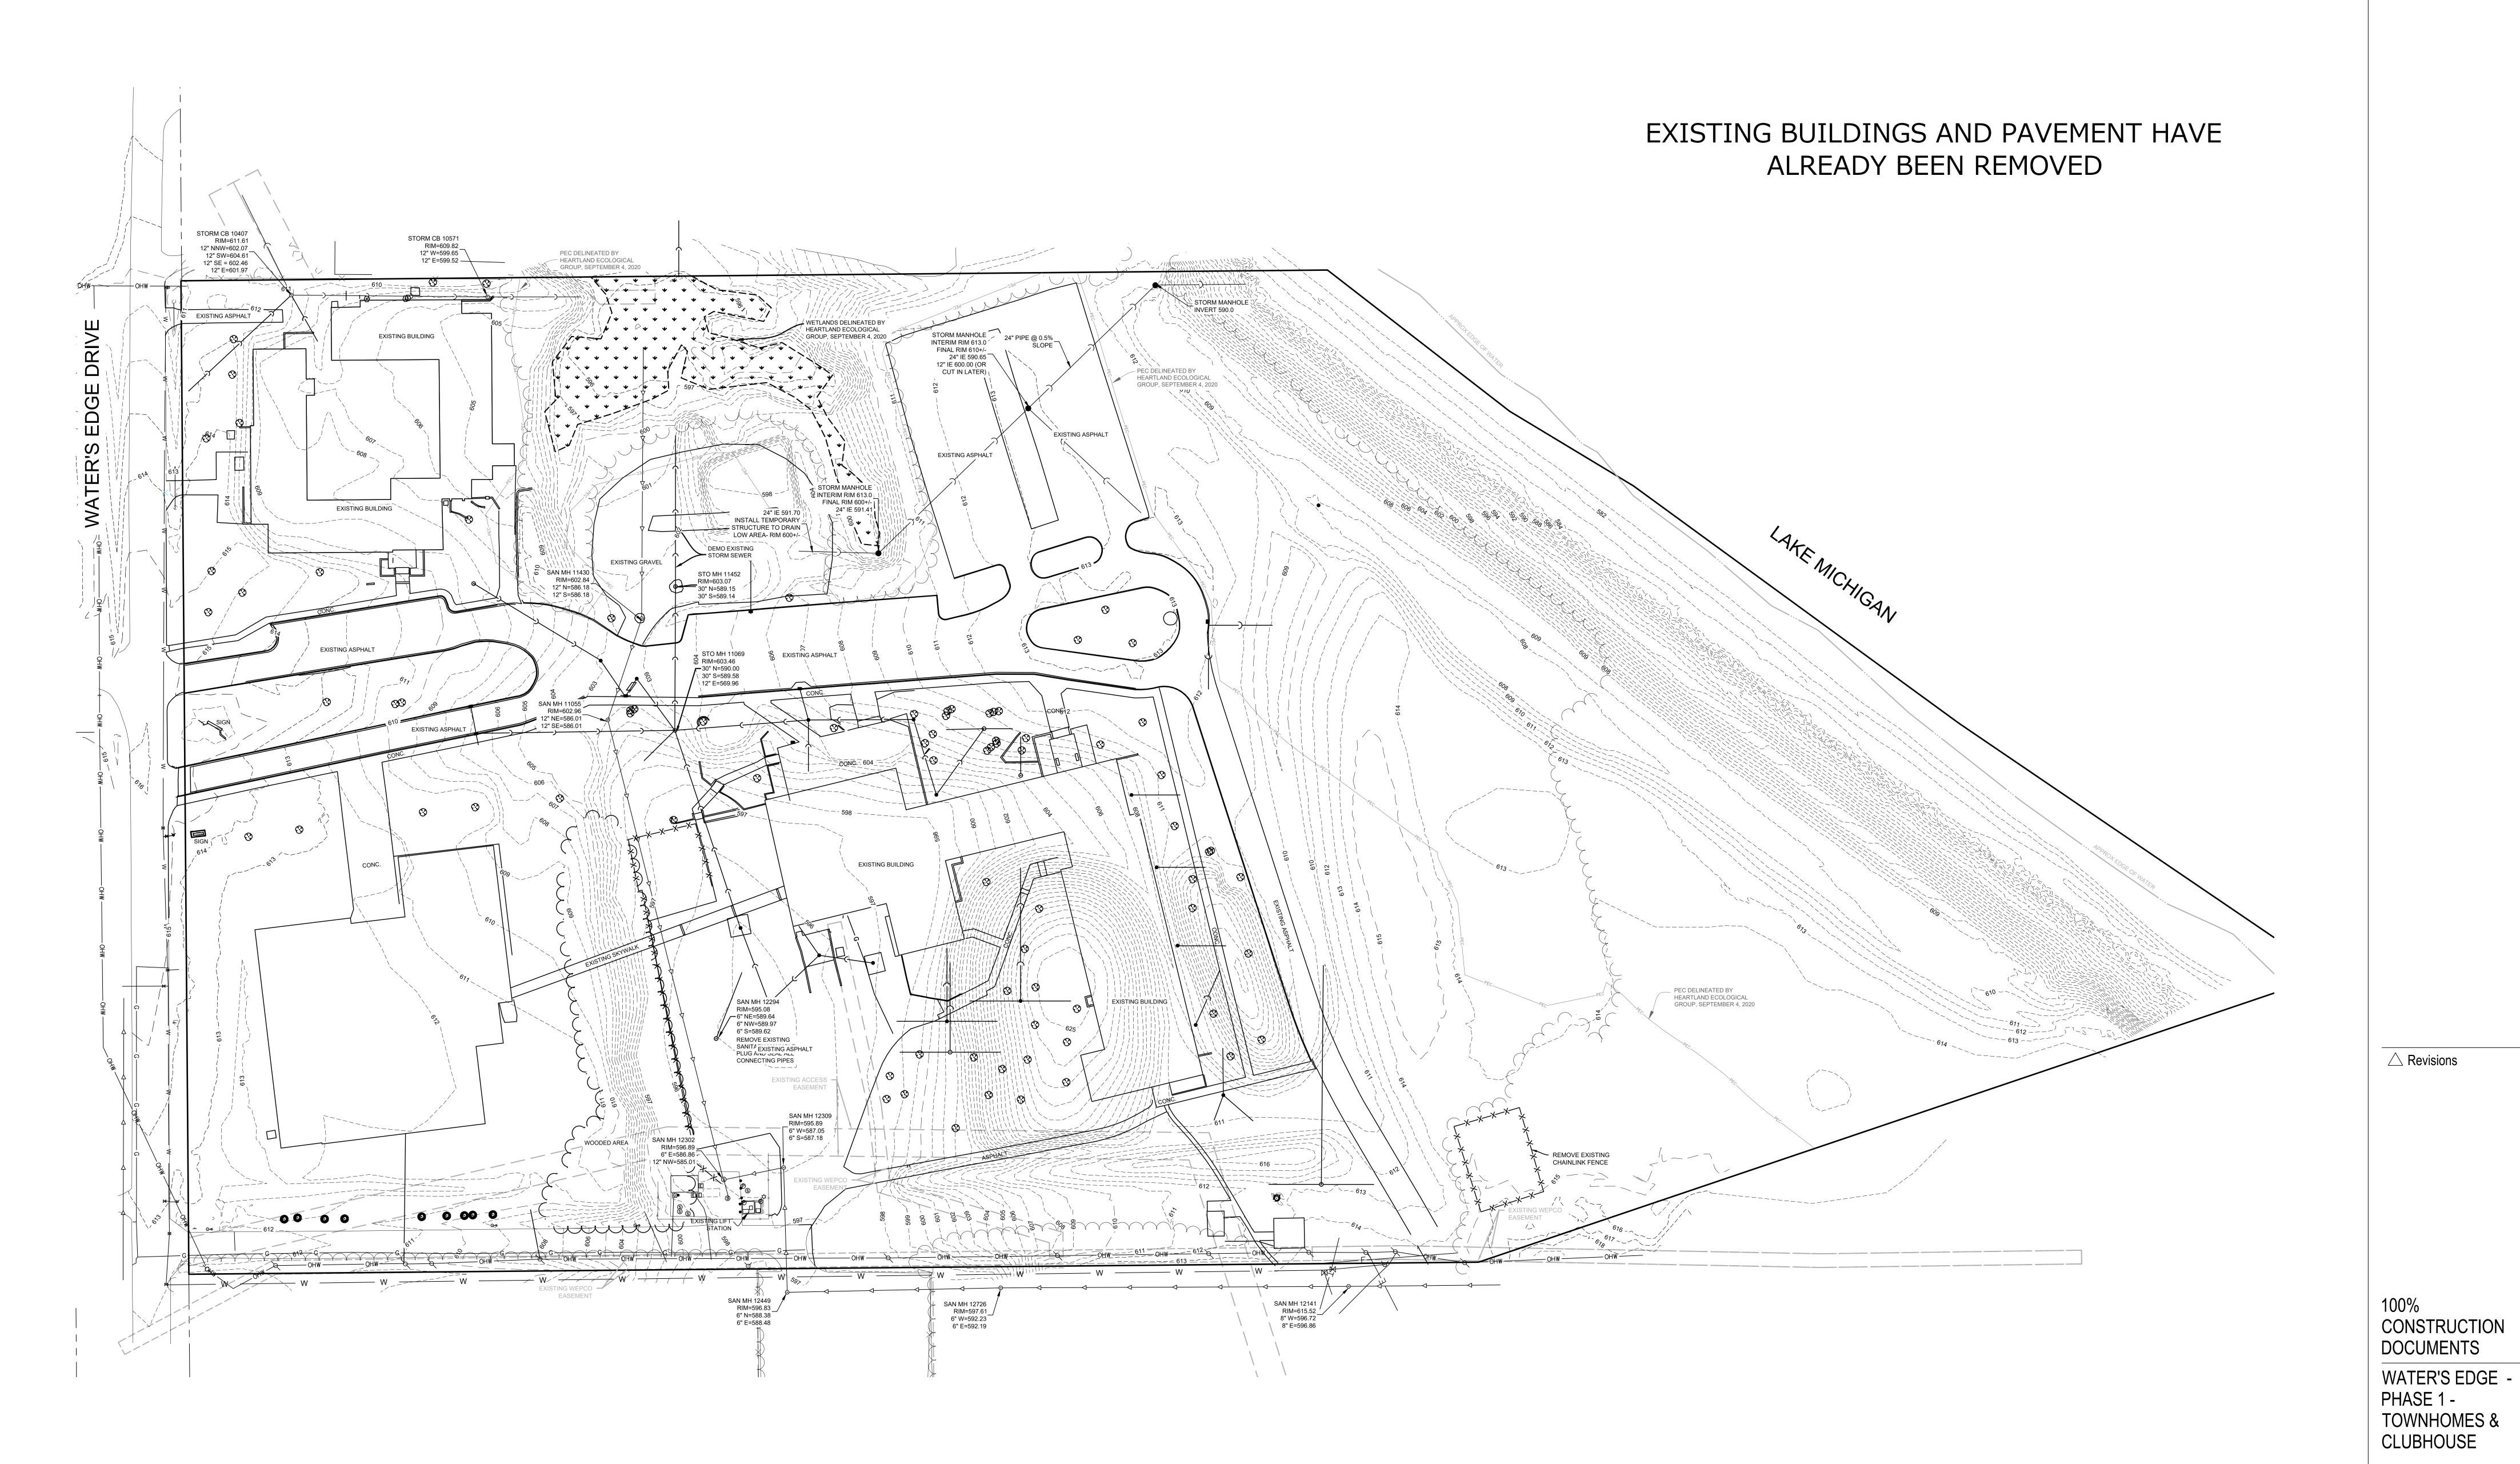



**PINNACLE** ENGINEERING GROUP ENGINEERING I NATURAL RESOURCES I SURVEYING 20725 WATERTOWN ROAD, SUITE 100 BROOKFIELD, WI 53186 (262) 754-8888 PEG PROJECT #: 2145.00

**EXISTING** CONDITIONS

Sheet Title

TOWNHOMES &

Water's Edge Road Caledonia, WI 53108

Date Issued: 12/12/2023


RINKA project #: 220504

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Sheet # C100





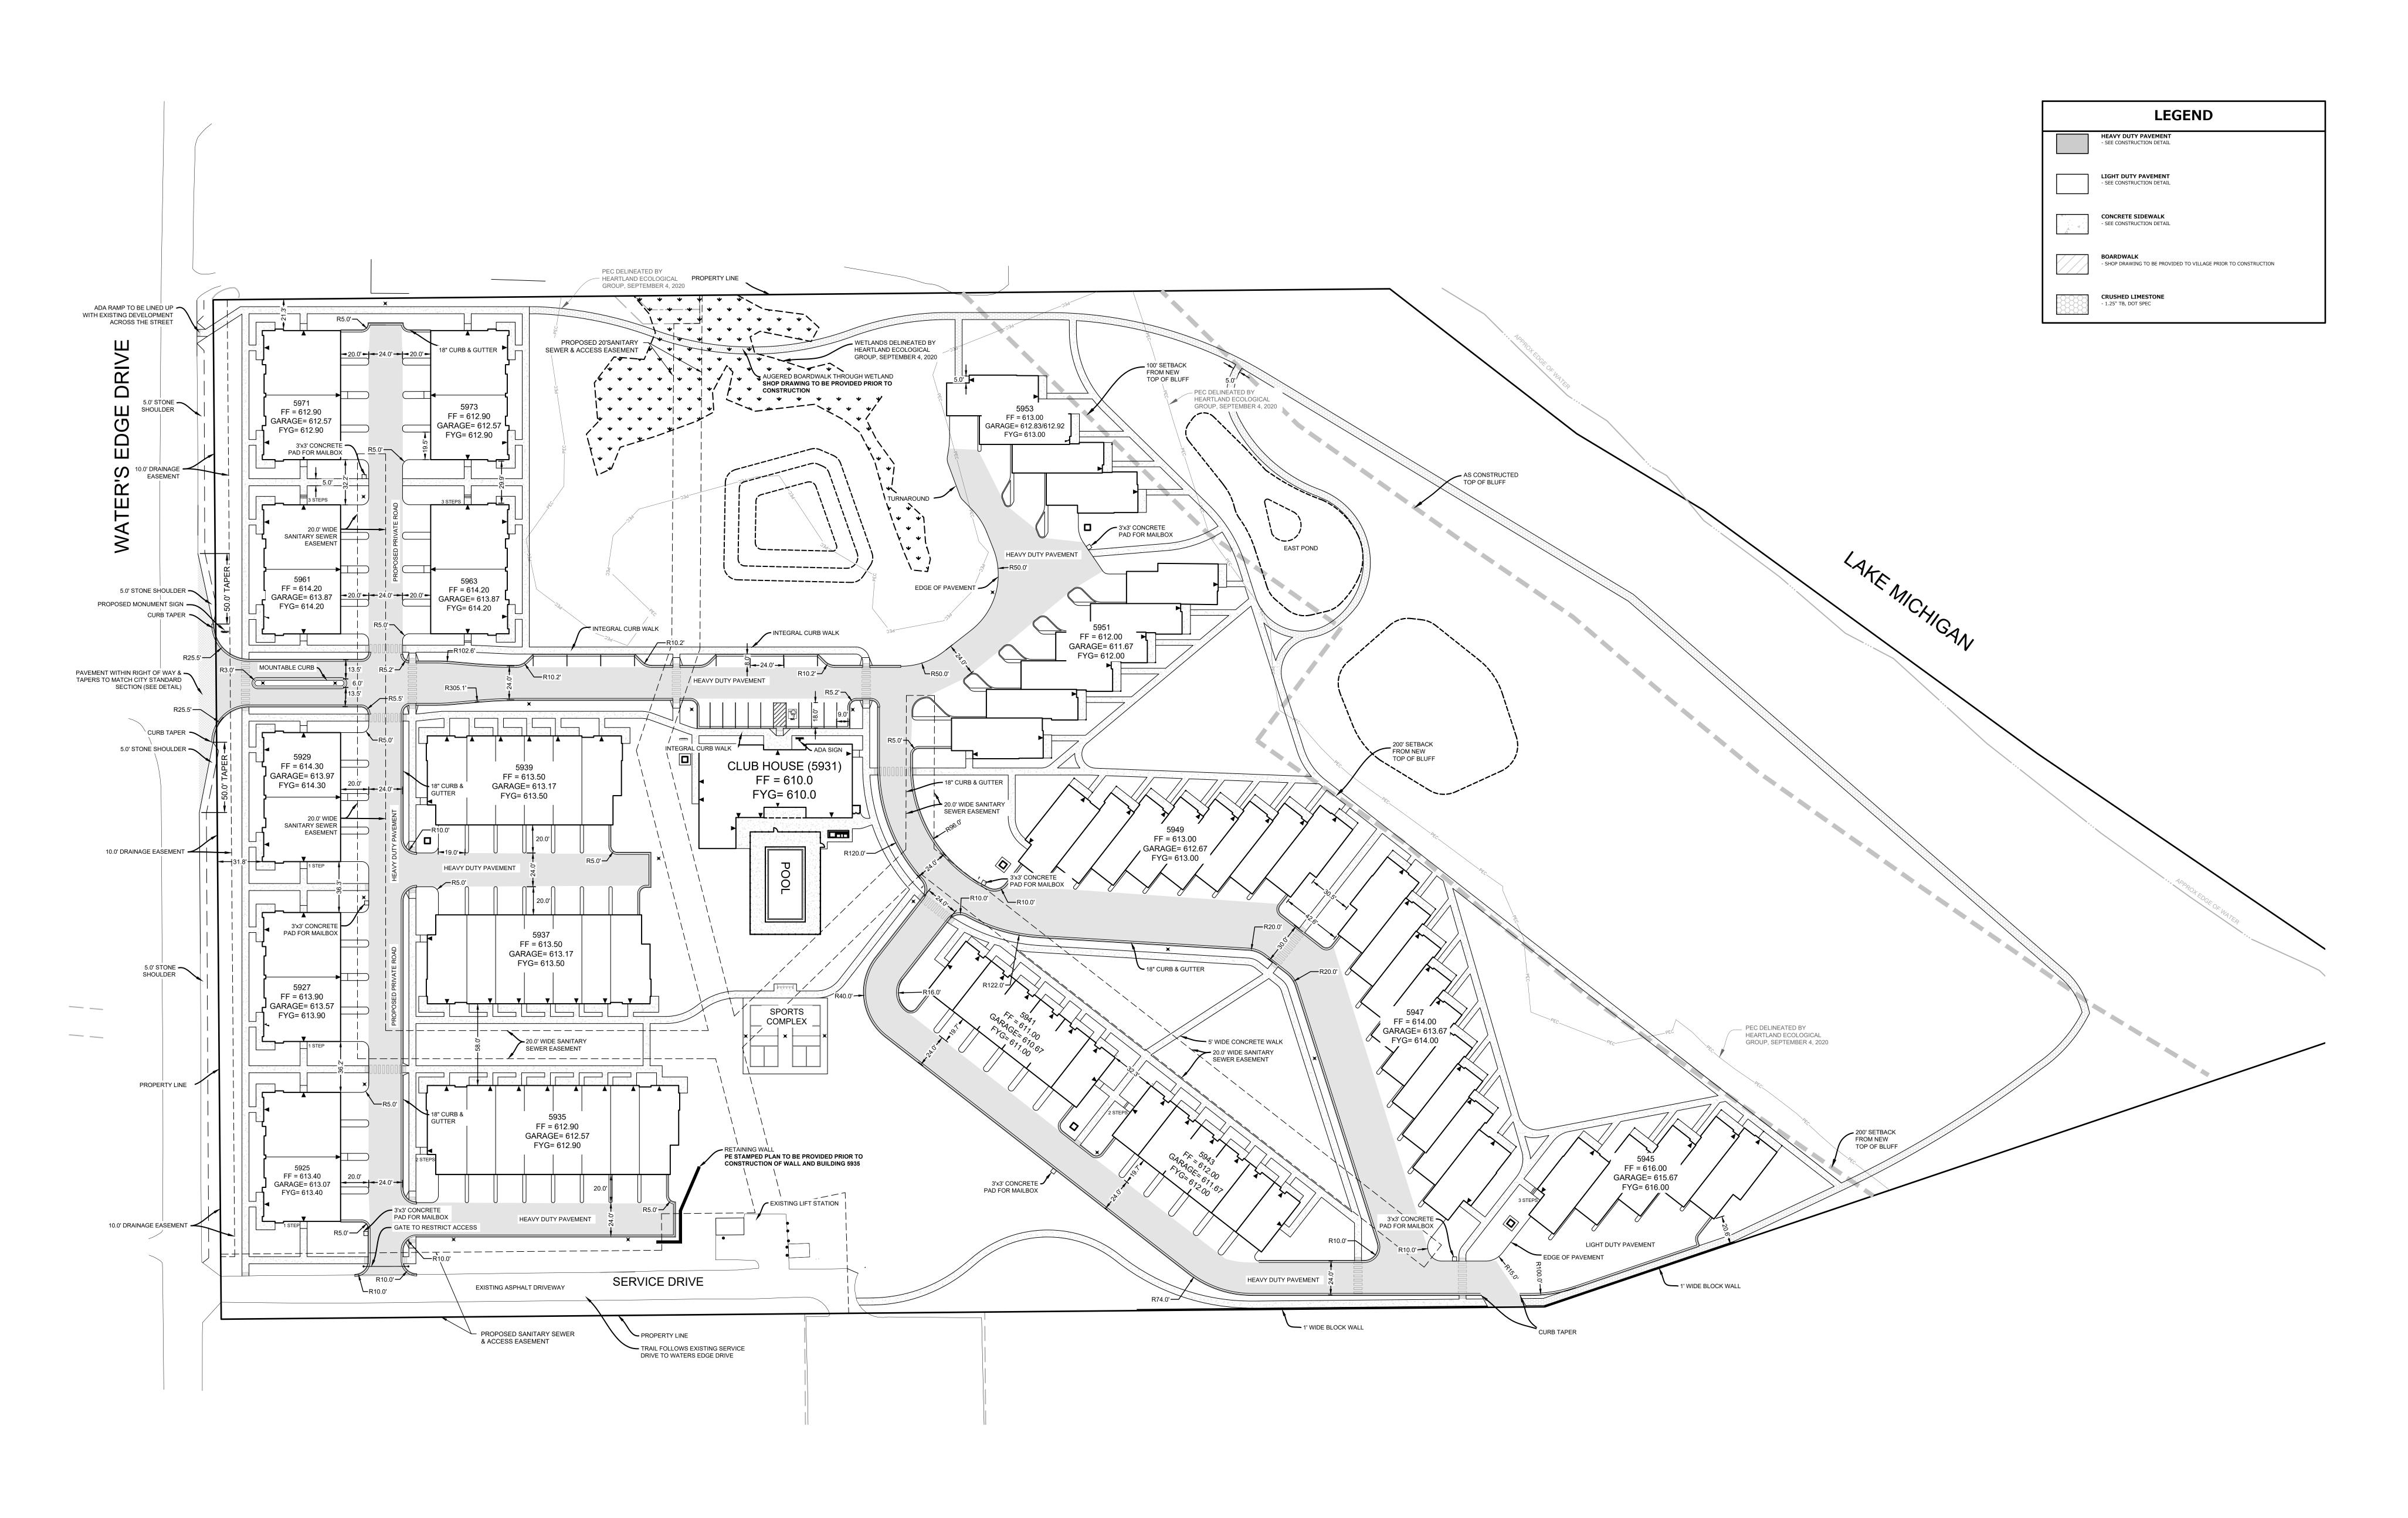

**PINNACLE** ENGINEERING GROUP ENGINEERING I NATURAL RESOURCES I SURVEYING 20725 WATERTOWN ROAD, SUITE 100 BROOKFIELD, WI 53186 (262) 754-8888 PEG PROJECT #: 2145.00

100% CONSTRUCTION **DOCUMENTS** 

WATER'S EDGE -PHASE 1 -TOWNHOMES & CLUBHOUSE


Water's Edge Road Caledonia, WI 53108 Date Issued: 12/12/2023 RINKA project #: 220504 Sheet Title

SITE PLAN

Sheet#

C101



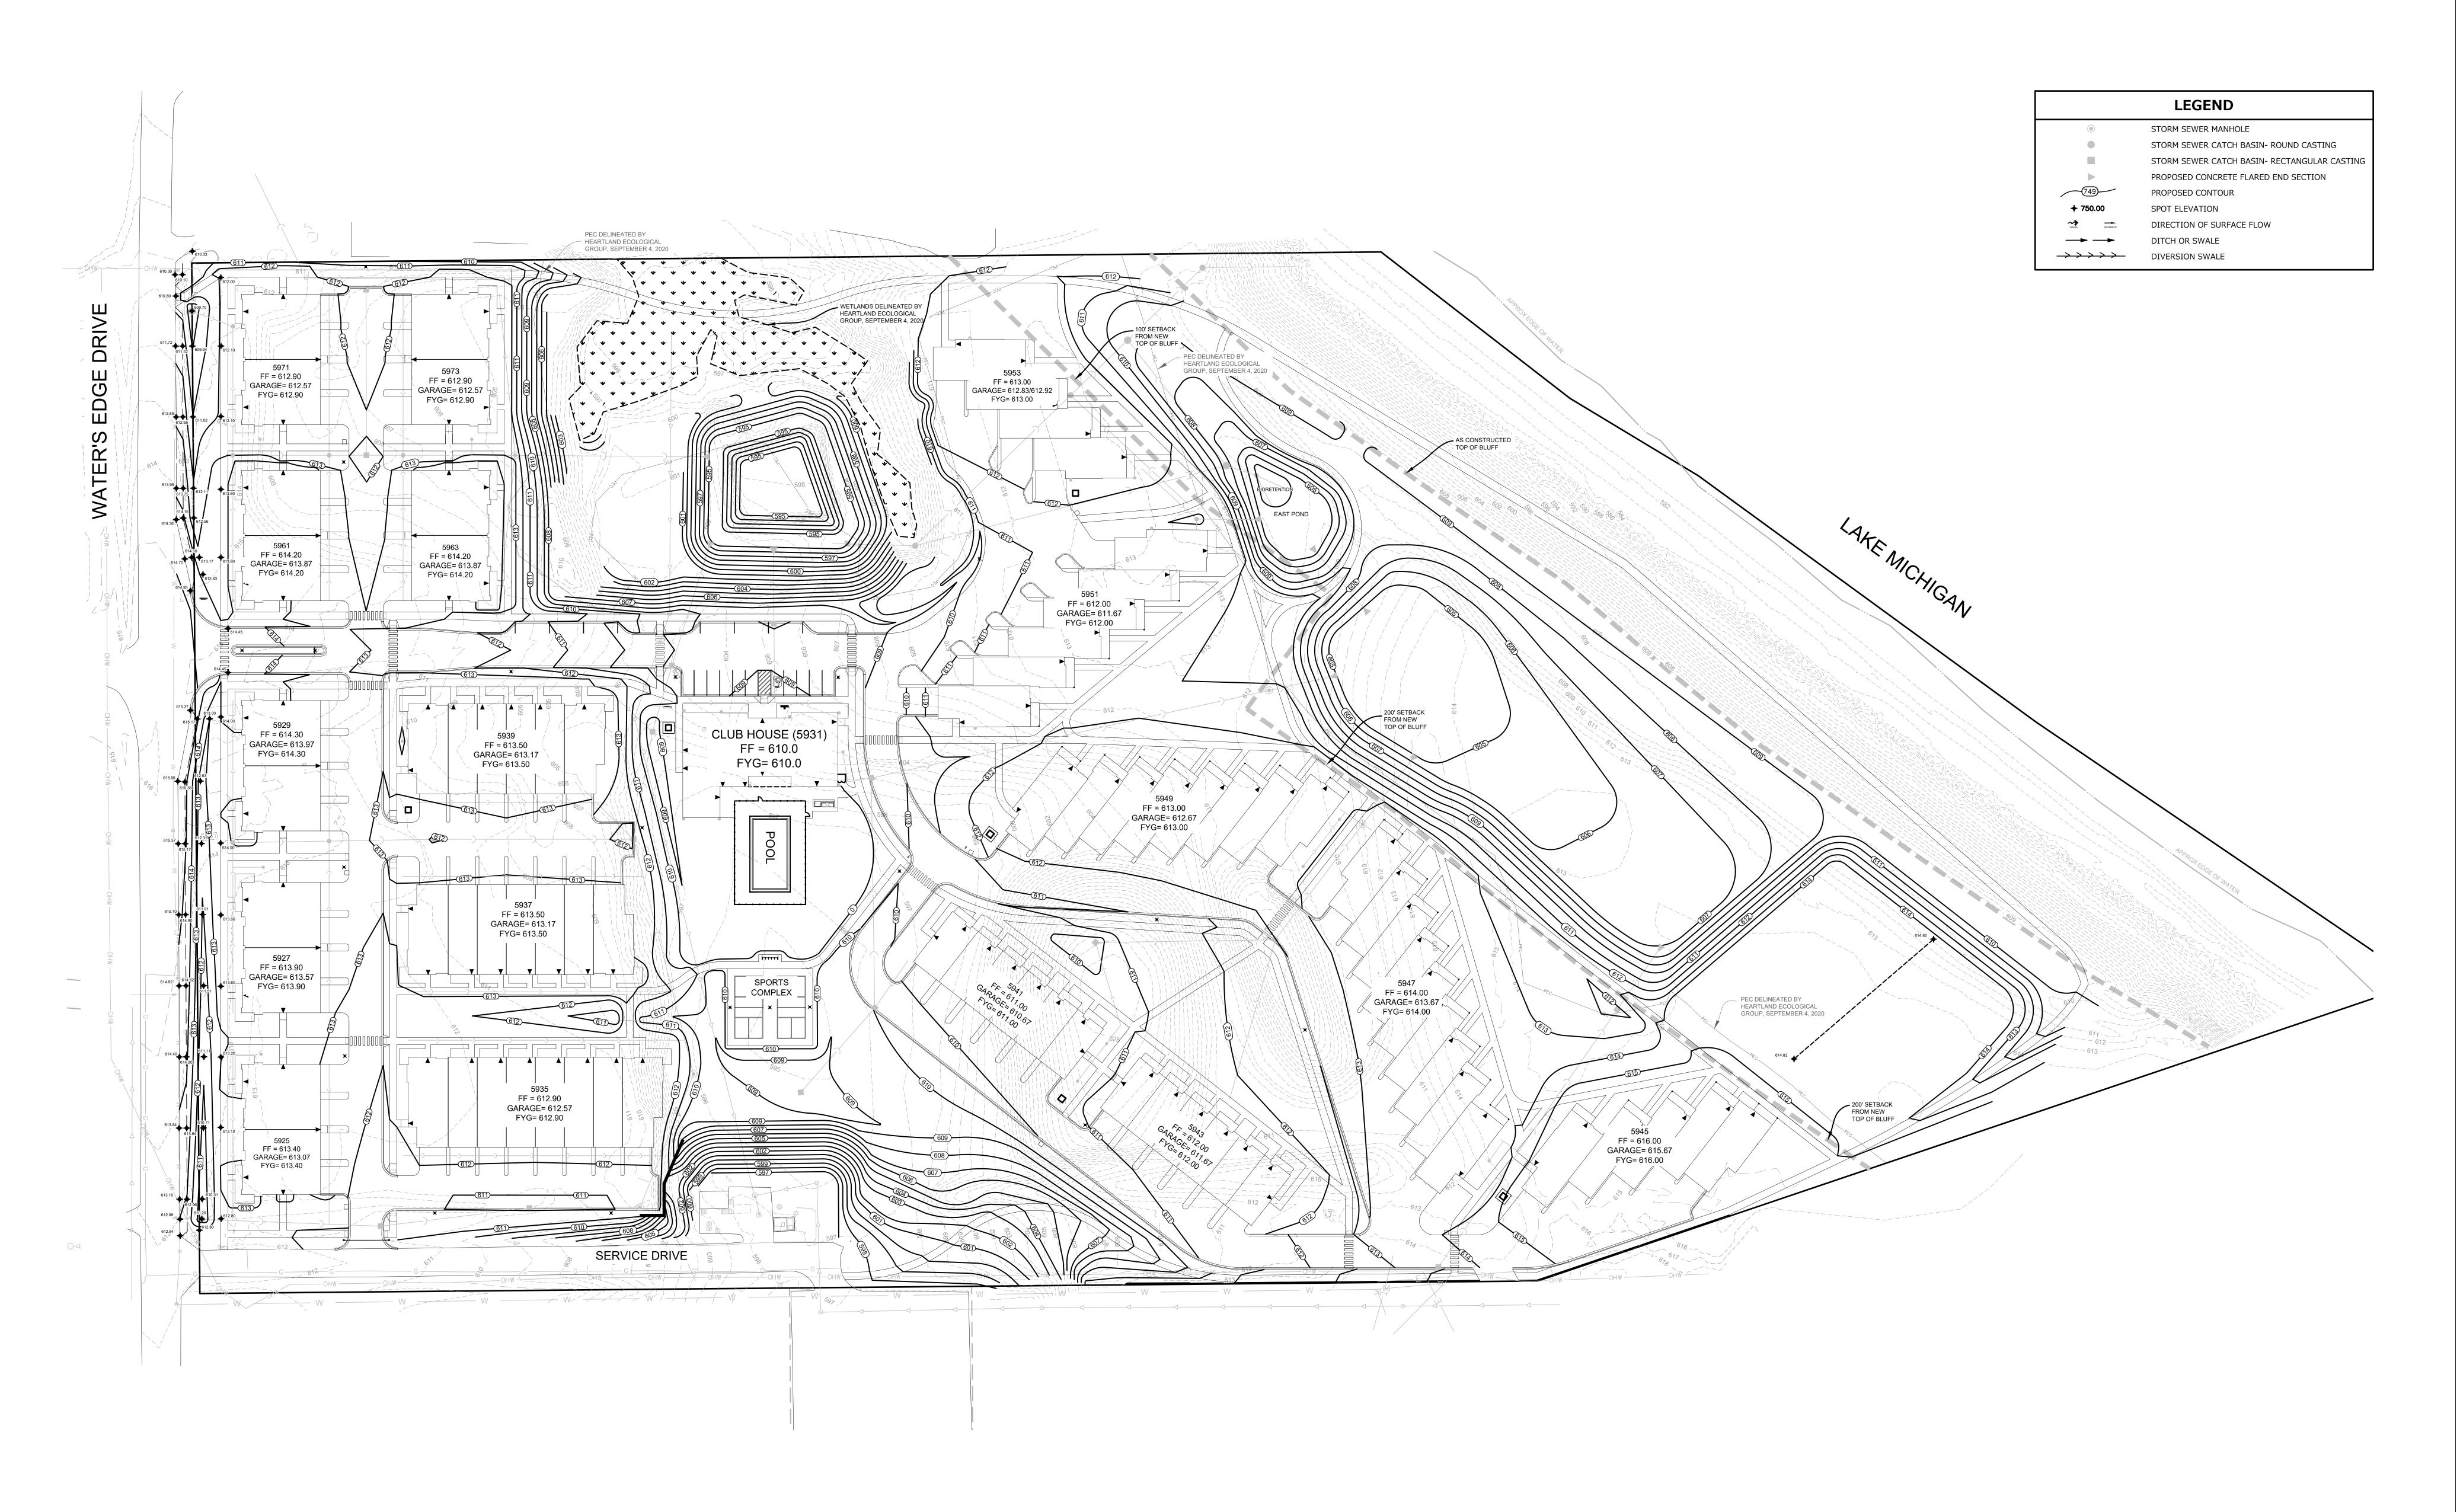





PINNACLE ENGINEERING GROUP
ENGINEERING I NATURAL RESOURCES I SURVEYING
20725 WATERTOWN ROAD, SUITE 100
BROOKFIELD, WI 53186
(262) 754-8888
PEG PROJECT #: 2145.00

△ Revisions

100% CONSTRUCTION **DOCUMENTS** 

WATER'S EDGE -PHASE 1 -TOWNHOMES & CLUBHOUSE


Water's Edge Road Caledonia, WI 53108 Date Issued: 12/12/2023 RINKA project #: 220504 Sheet Title

**GRADING PLAN** 

C102

Sheet #



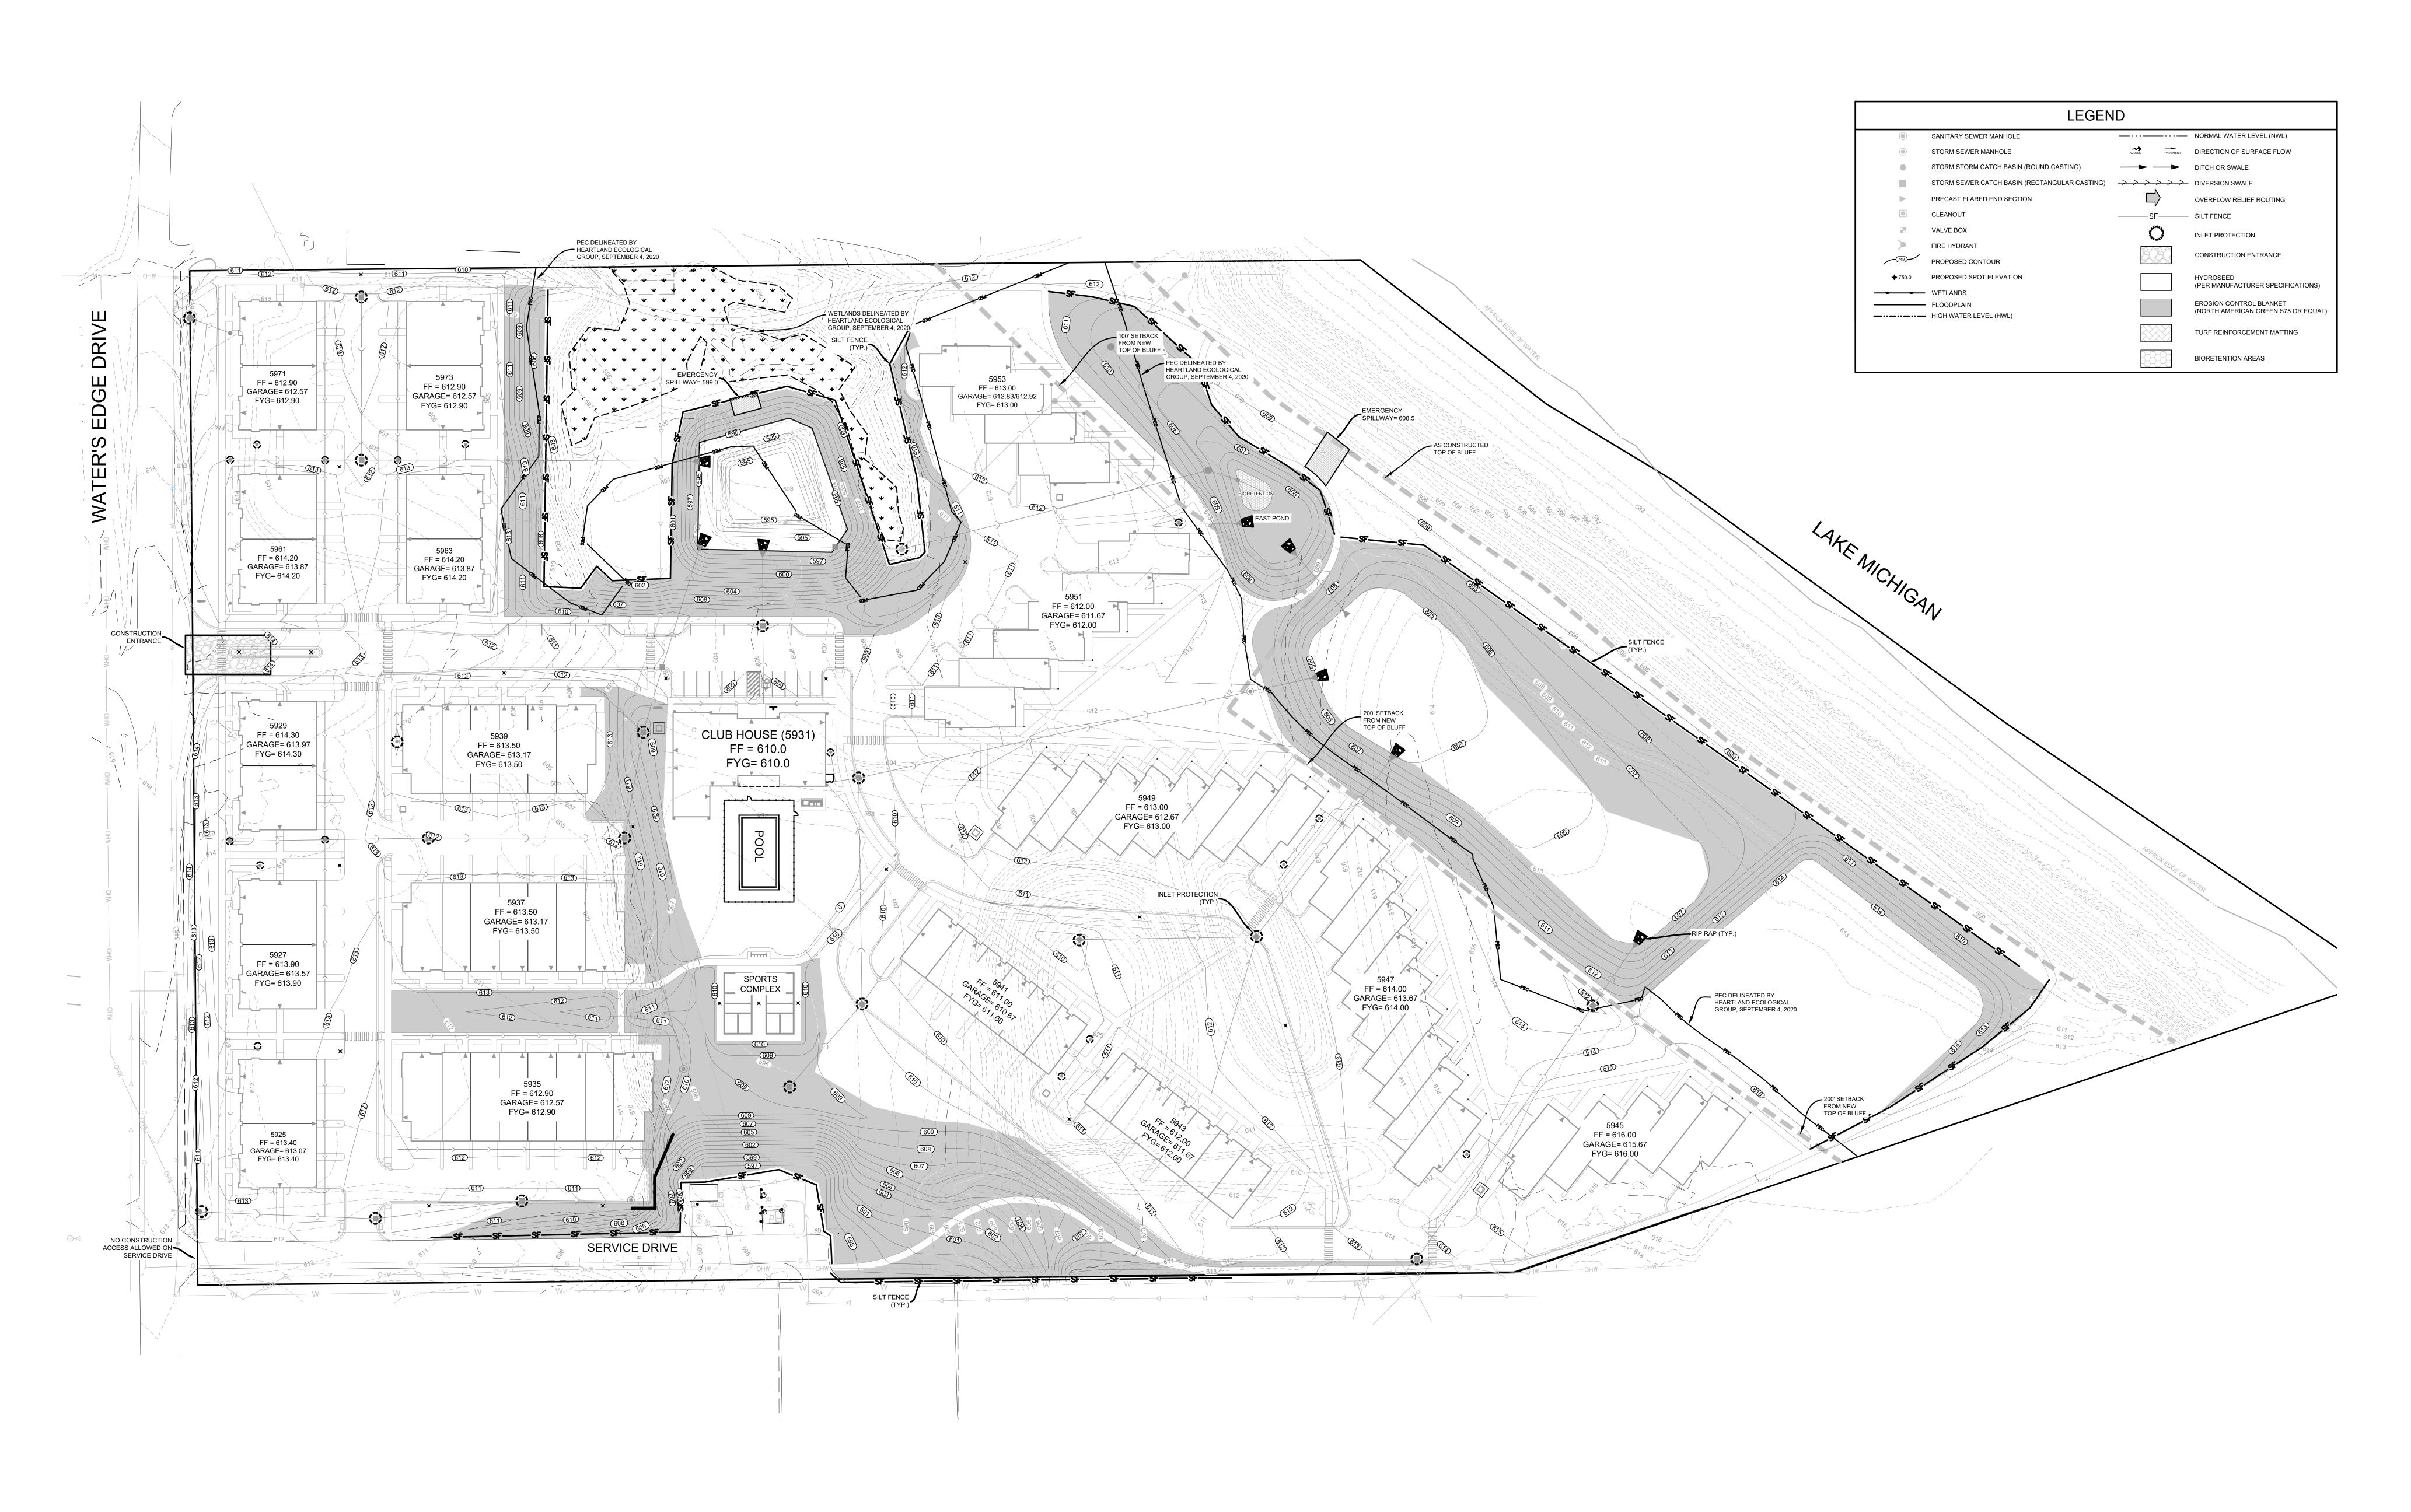





**PINNACLE** ENGINEERING GROUP ENGINEERING I NATURAL RESOURCES I SURVEYING 20725 WATERTOWN ROAD, SUITE 100 BROOKFIELD, WI 53186 (262) 754-8888 PEG PROJECT #: 2145.00

△ Revisions

100% CONSTRUCTION **DOCUMENTS** 


WATER'S EDGE -PHASE 1 -TOWNHOMES & CLUBHOUSE

Water's Edge Road Caledonia, WI 53108 Date Issued: 12/12/2023 RINKA project #: 220504 Sheet Title

**EROSION CONTROL** PLAN Sheet #

C103



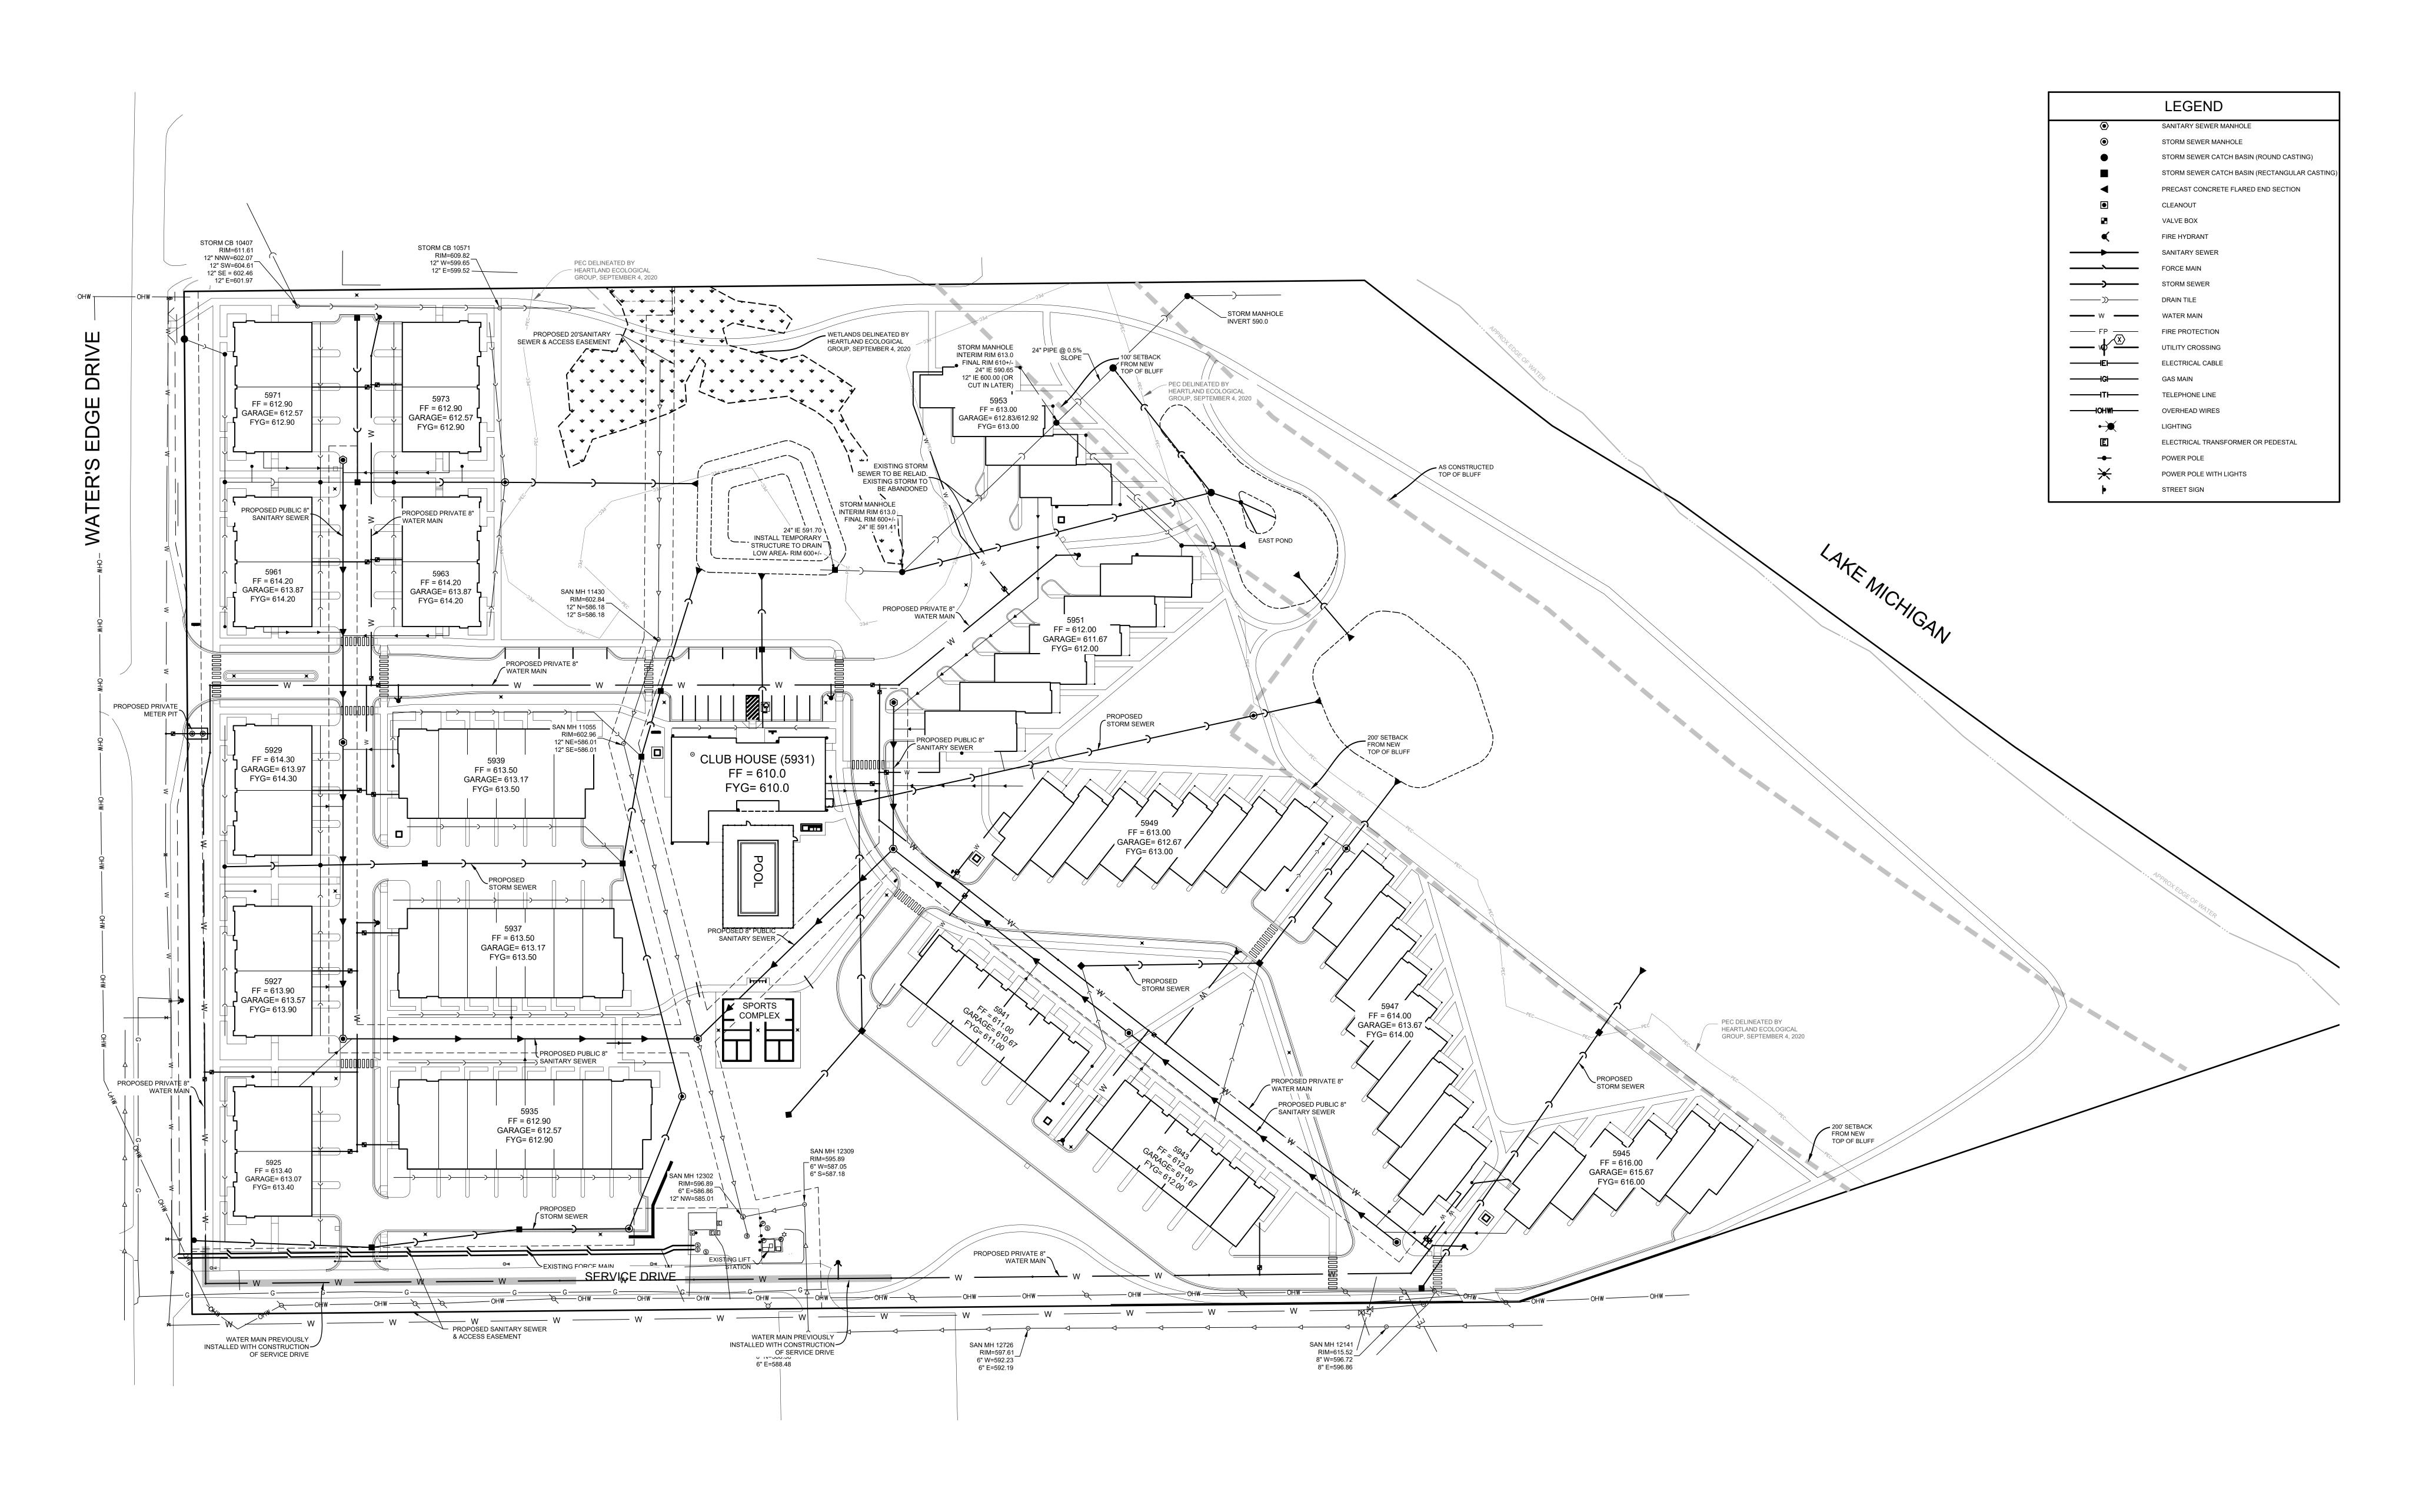





**PINNACLE** ENGINEERING GROUP ENGINEERING I NATURAL RESOURCES I SURVEYING 20725 WATERTOWN ROAD, SUITE 100 BROOKFIELD, WI 53186 (262) 754-8888 PEG PROJECT #: 2145.00

 $\triangle$  Revisions

100% CONSTRUCTION **DOCUMENTS** 

WATER'S EDGE -PHASE 1 -TOWNHOMES & CLUBHOUSE

Water's Edge Road Caledonia, WI 53108 Date Issued: 12/12/2023 RINKA project #: 220504


Sheet Title

Sheet #

OVERALL UTILITY PLAN

C104



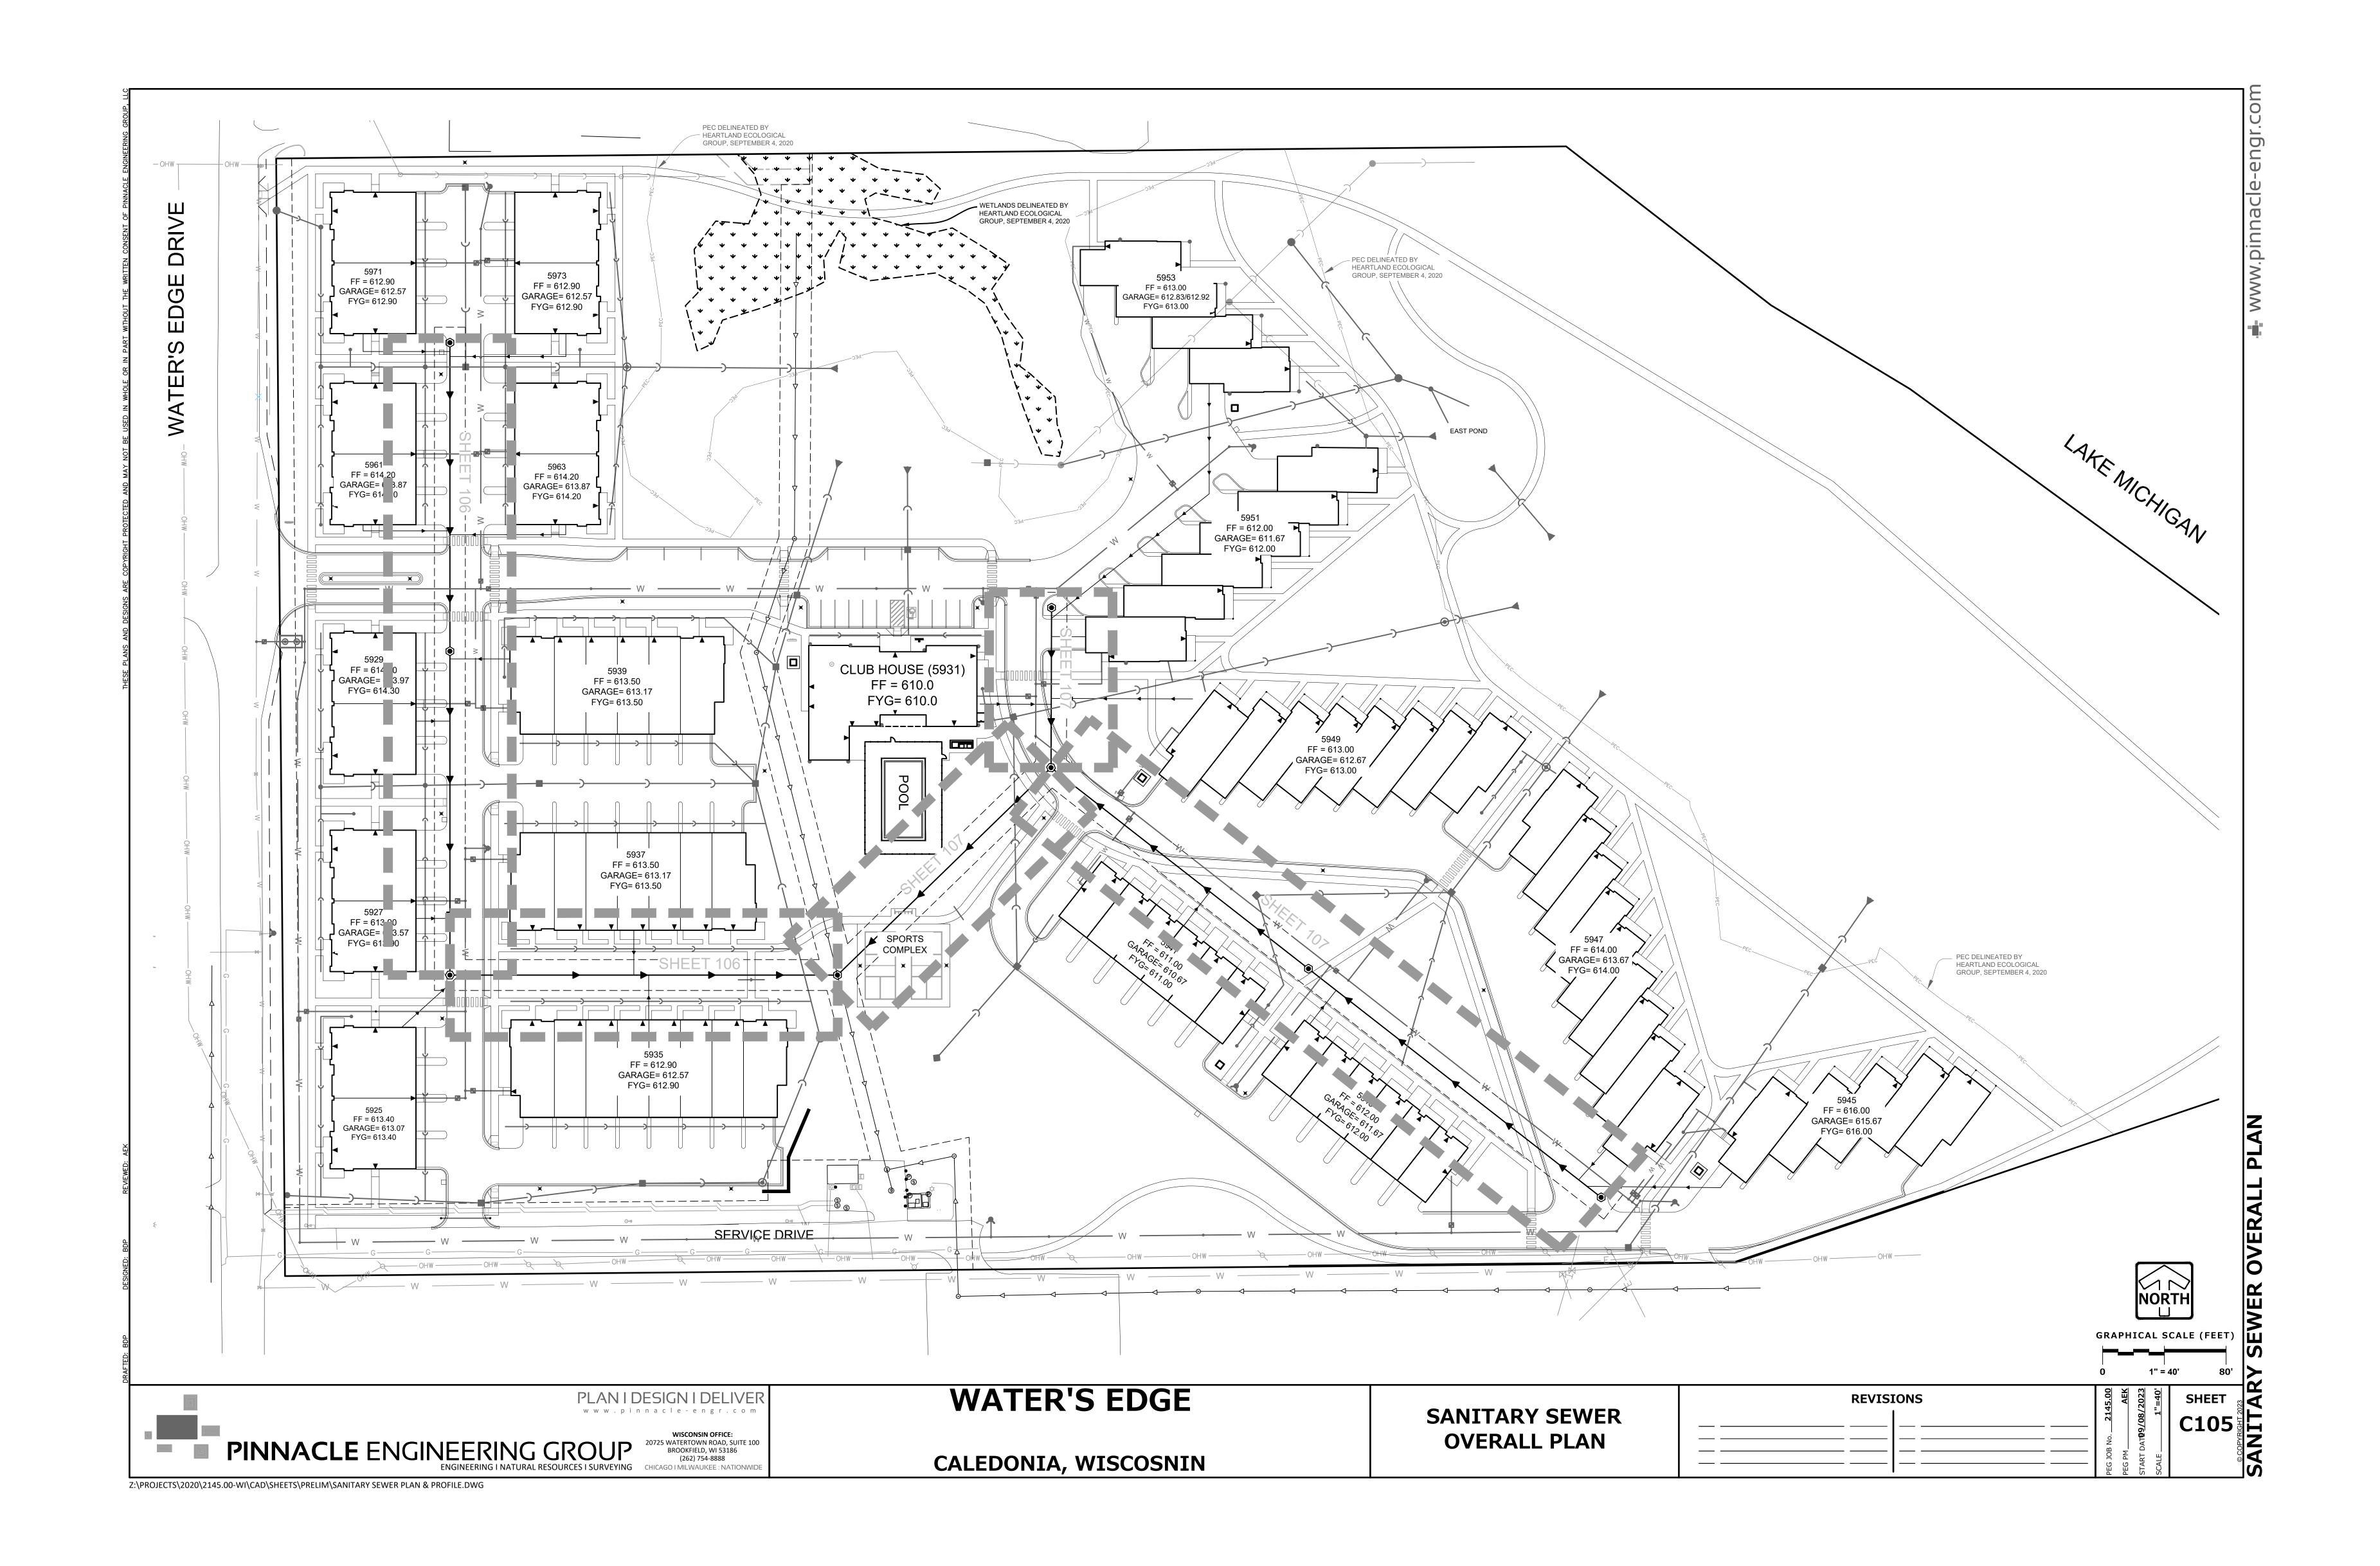

100% CONSTRUCTION DOCUMENTS


WATER'S EDGE PHASE 1 TOWNHOMES &
CLUBHOUSE

Water's Edge Road Caledonia, WI 53108 Date Issued: 12/12/2023 RINKA project #: 220504 Sheet Title

PINNACLE ENGINEERING GROUP
ENGINEERING I NATURAL RESOURCES I SURVEYING
20725 WATERTOWN ROAD, SUITE 100
BROOKFIELD, WI 53186
(262) 754-8888
PEG PROJECT #: 2145.00

SANITARY SEWER OVERALL PLAN

Sheet # C105

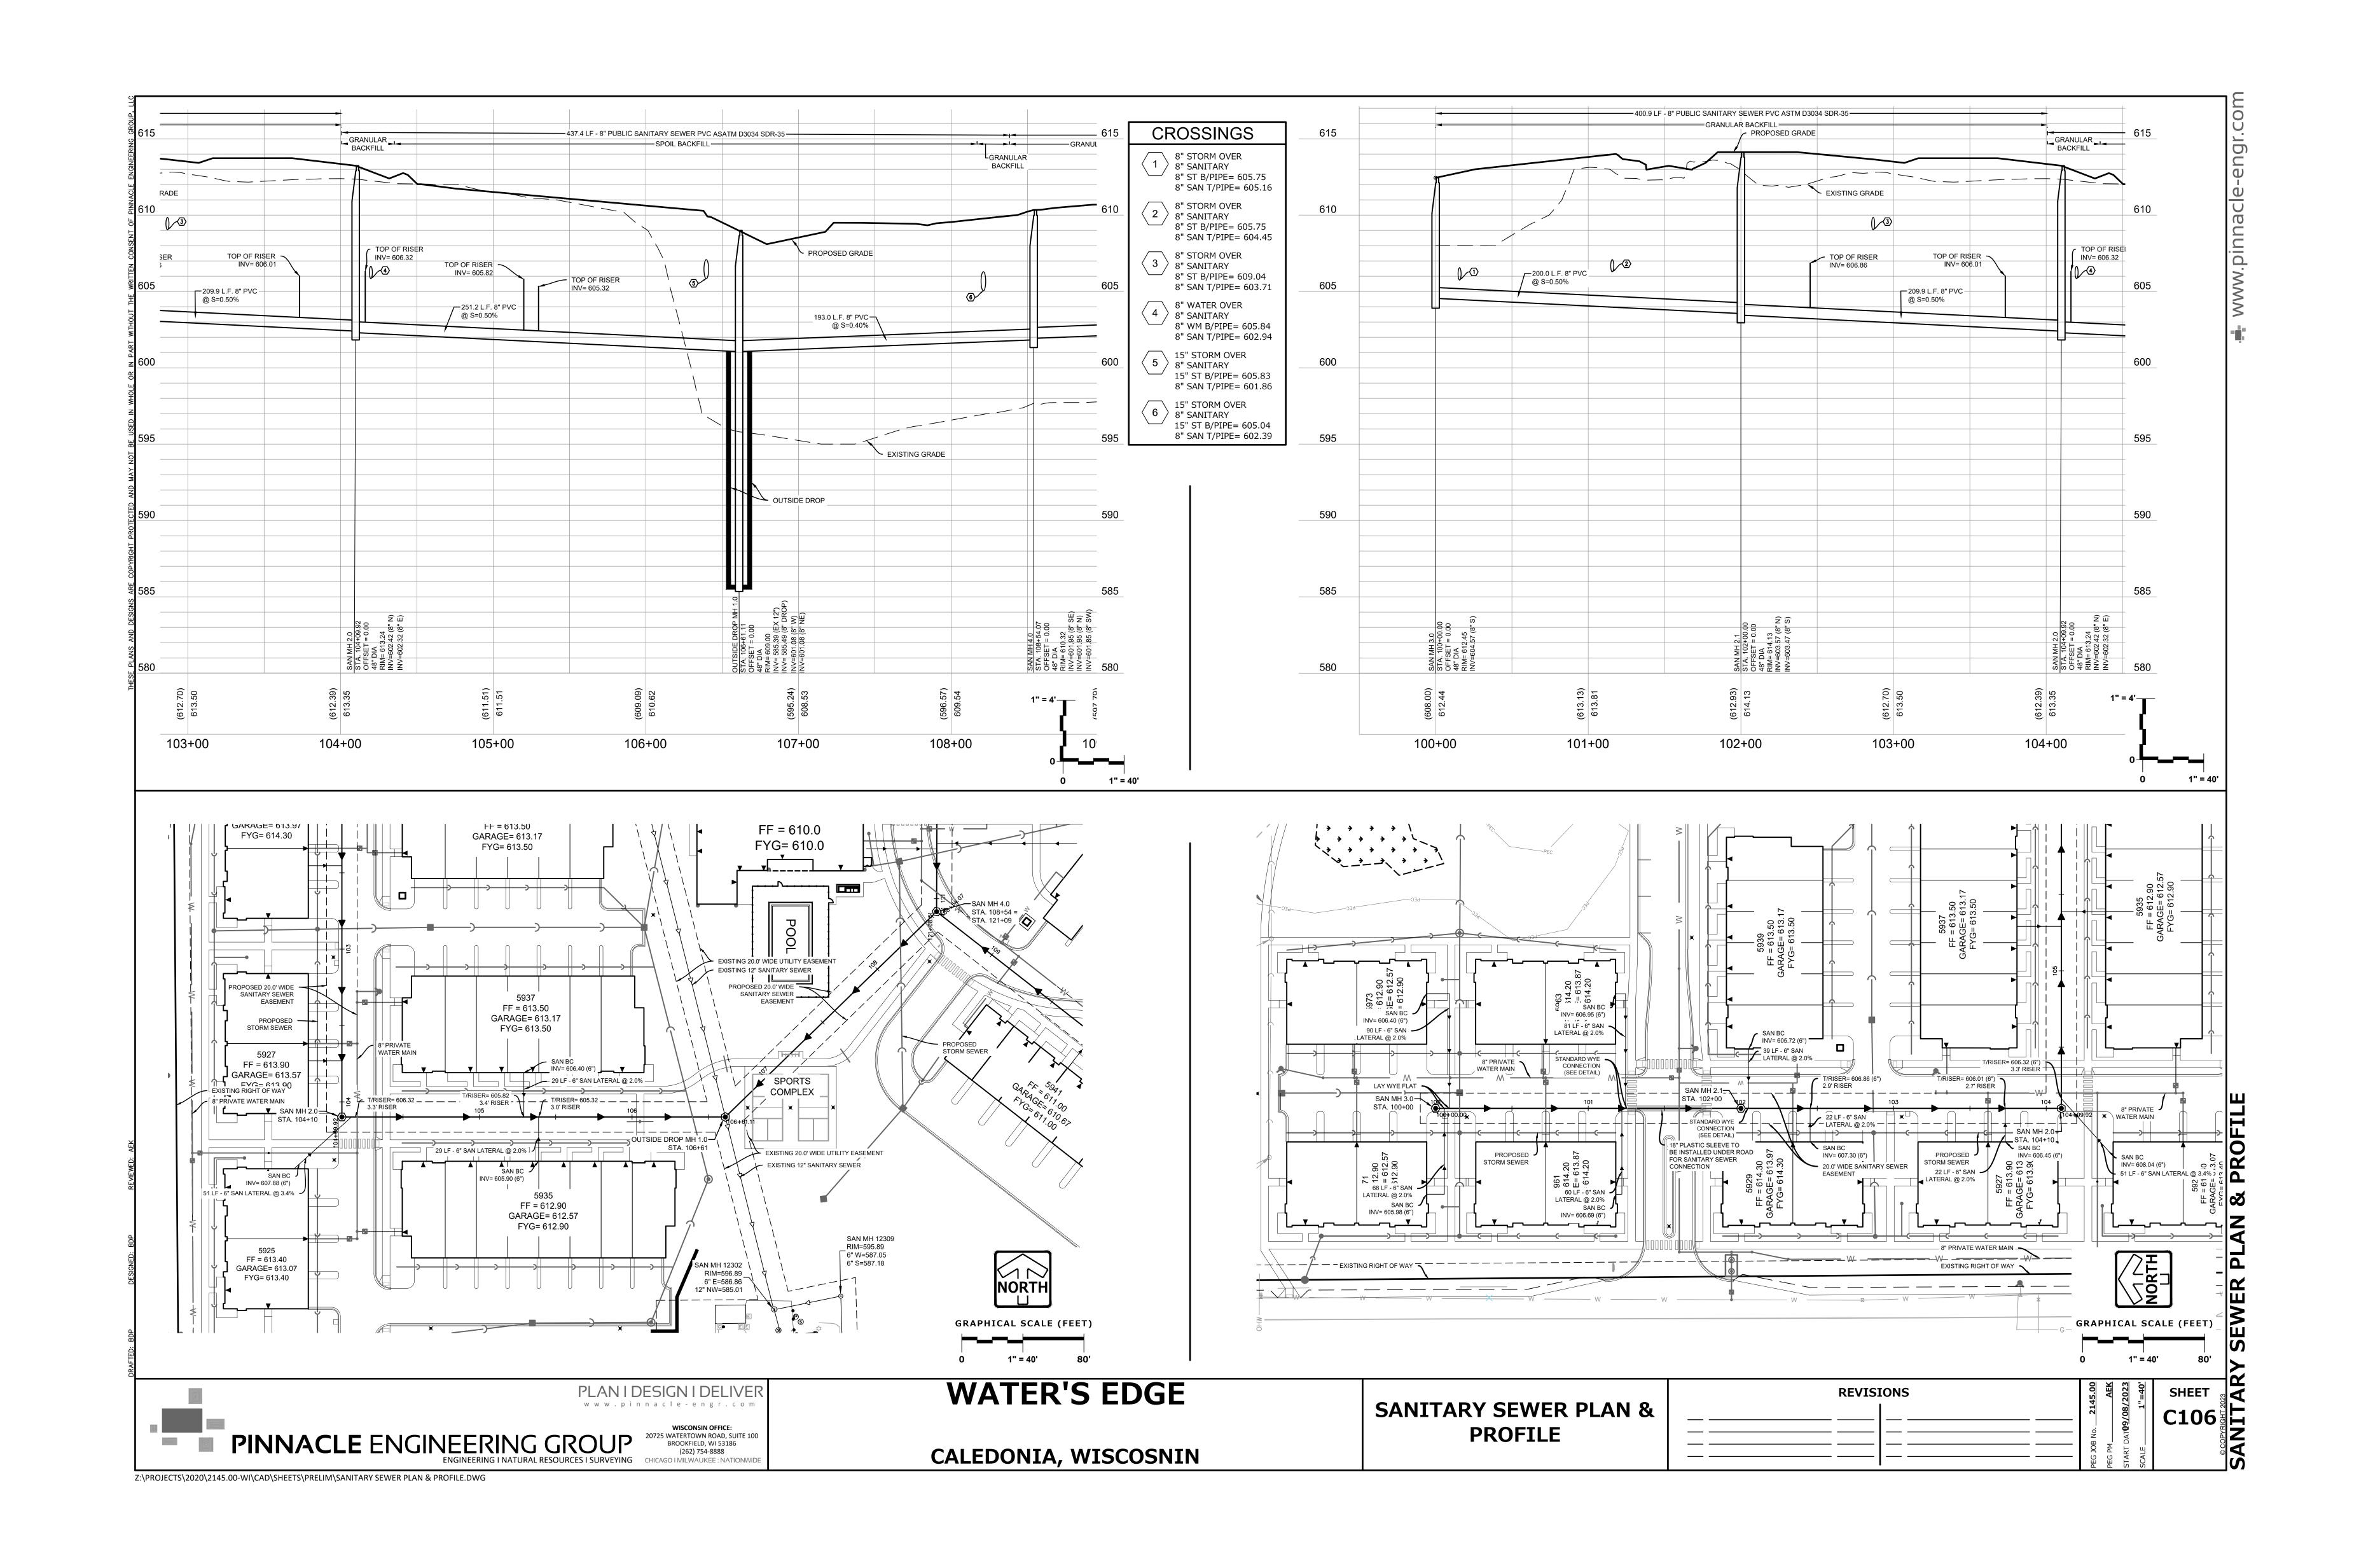

△ Revisions

100% CONSTRUCTION DOCUMENTS

WATER'S EDGE -PHASE 1 -TOWNHOMES & CLUBHOUSE

Water's Edge Road
Caledonia, WI 53108

Date Issued: 12/12/2023


RINKA project #: 220504
Sheet Title

PINNACLE ENGINEERING GROUP
ENGINEERING I NATURAL RESOURCES I SURVEYING
20725 WATERTOWN ROAD, SUITE 100
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(262) 754-8888

PEG PROJECT #: 2145.00

SANITARY SEWER PLAN & PROFILE

Sheet # C106

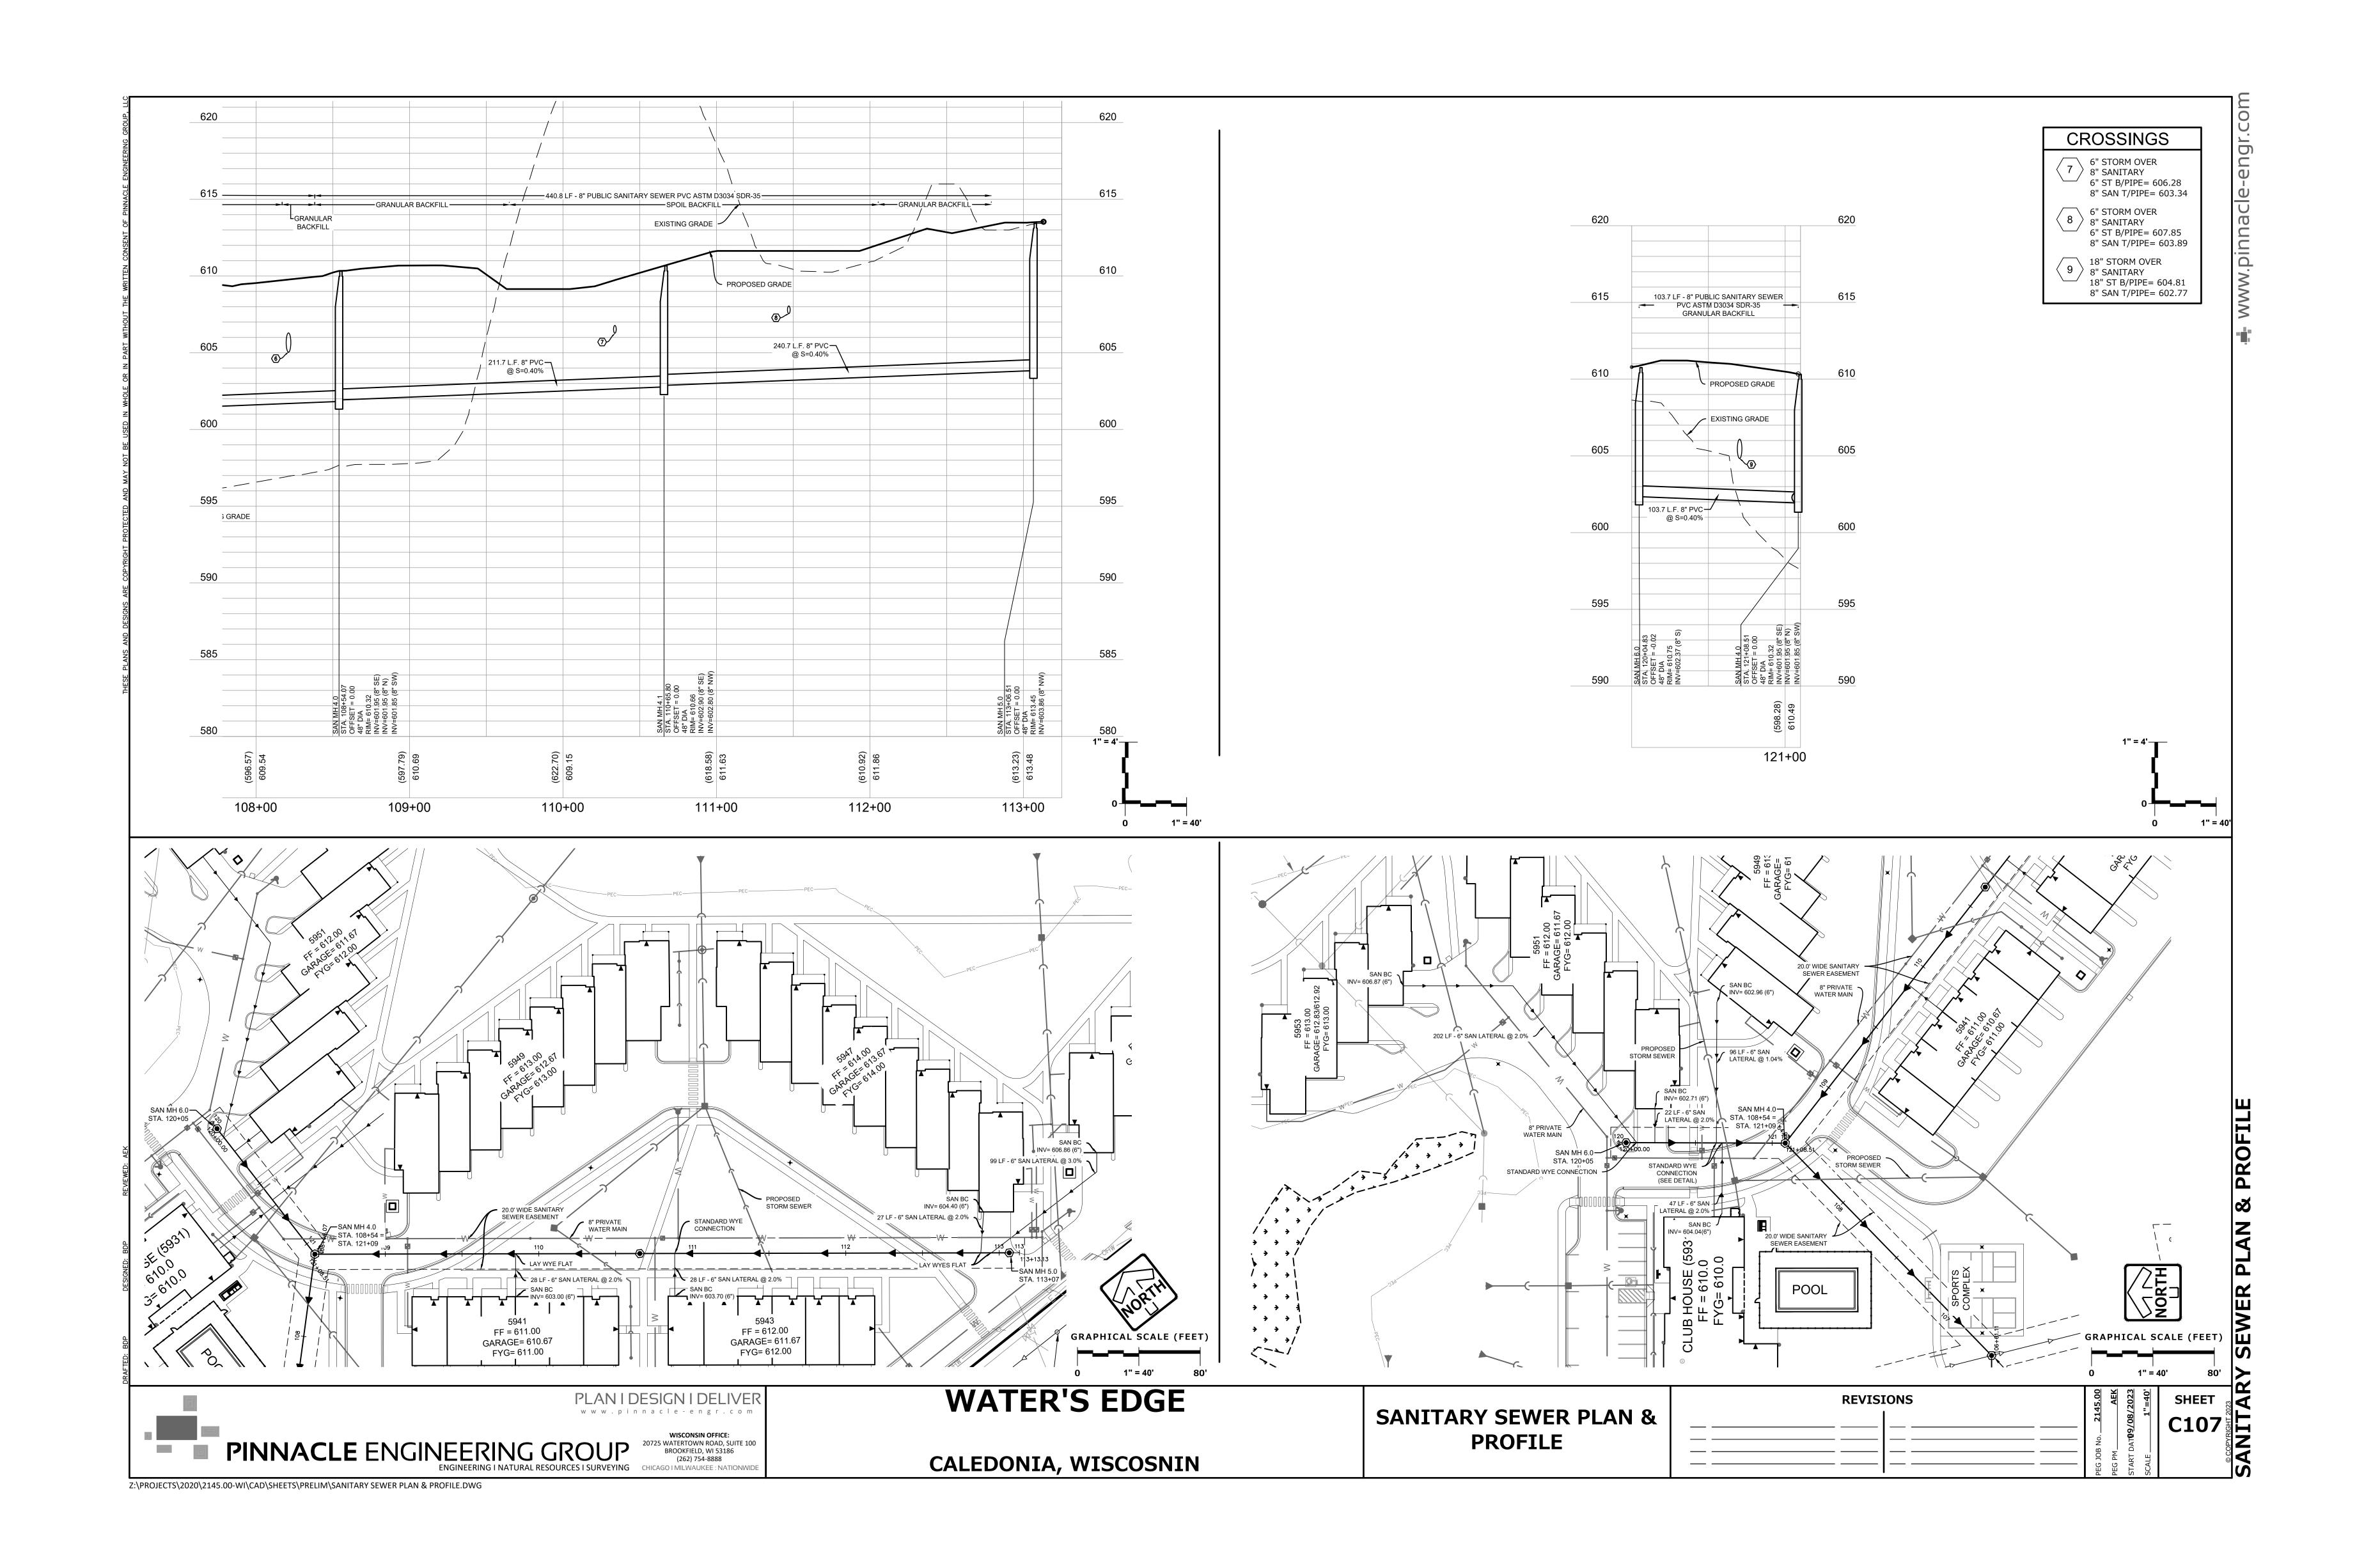

 $\triangle$  Revisions


100% CONSTRUCTION **DOCUMENTS** 

WATER'S EDGE -PHASE 1 -TOWNHOMES & CLUBHOUSE

Water's Edge Road Caledonia, WI 53108 Date Issued: 12/12/2023 RINKA project #: 220504 Sheet Title

**PINNACLE** ENGINEERING GROUP SANITARY SEWER ENGINEERING I NATURAL RESOURCES I SURVEYING 20725 WATERTOWN ROAD, SUITE 100 **PLAN & PROFILE** BROOKFIELD, WI 53186 (262) 754-8888 PEG PROJECT #: 2145.00

Sheet # C107

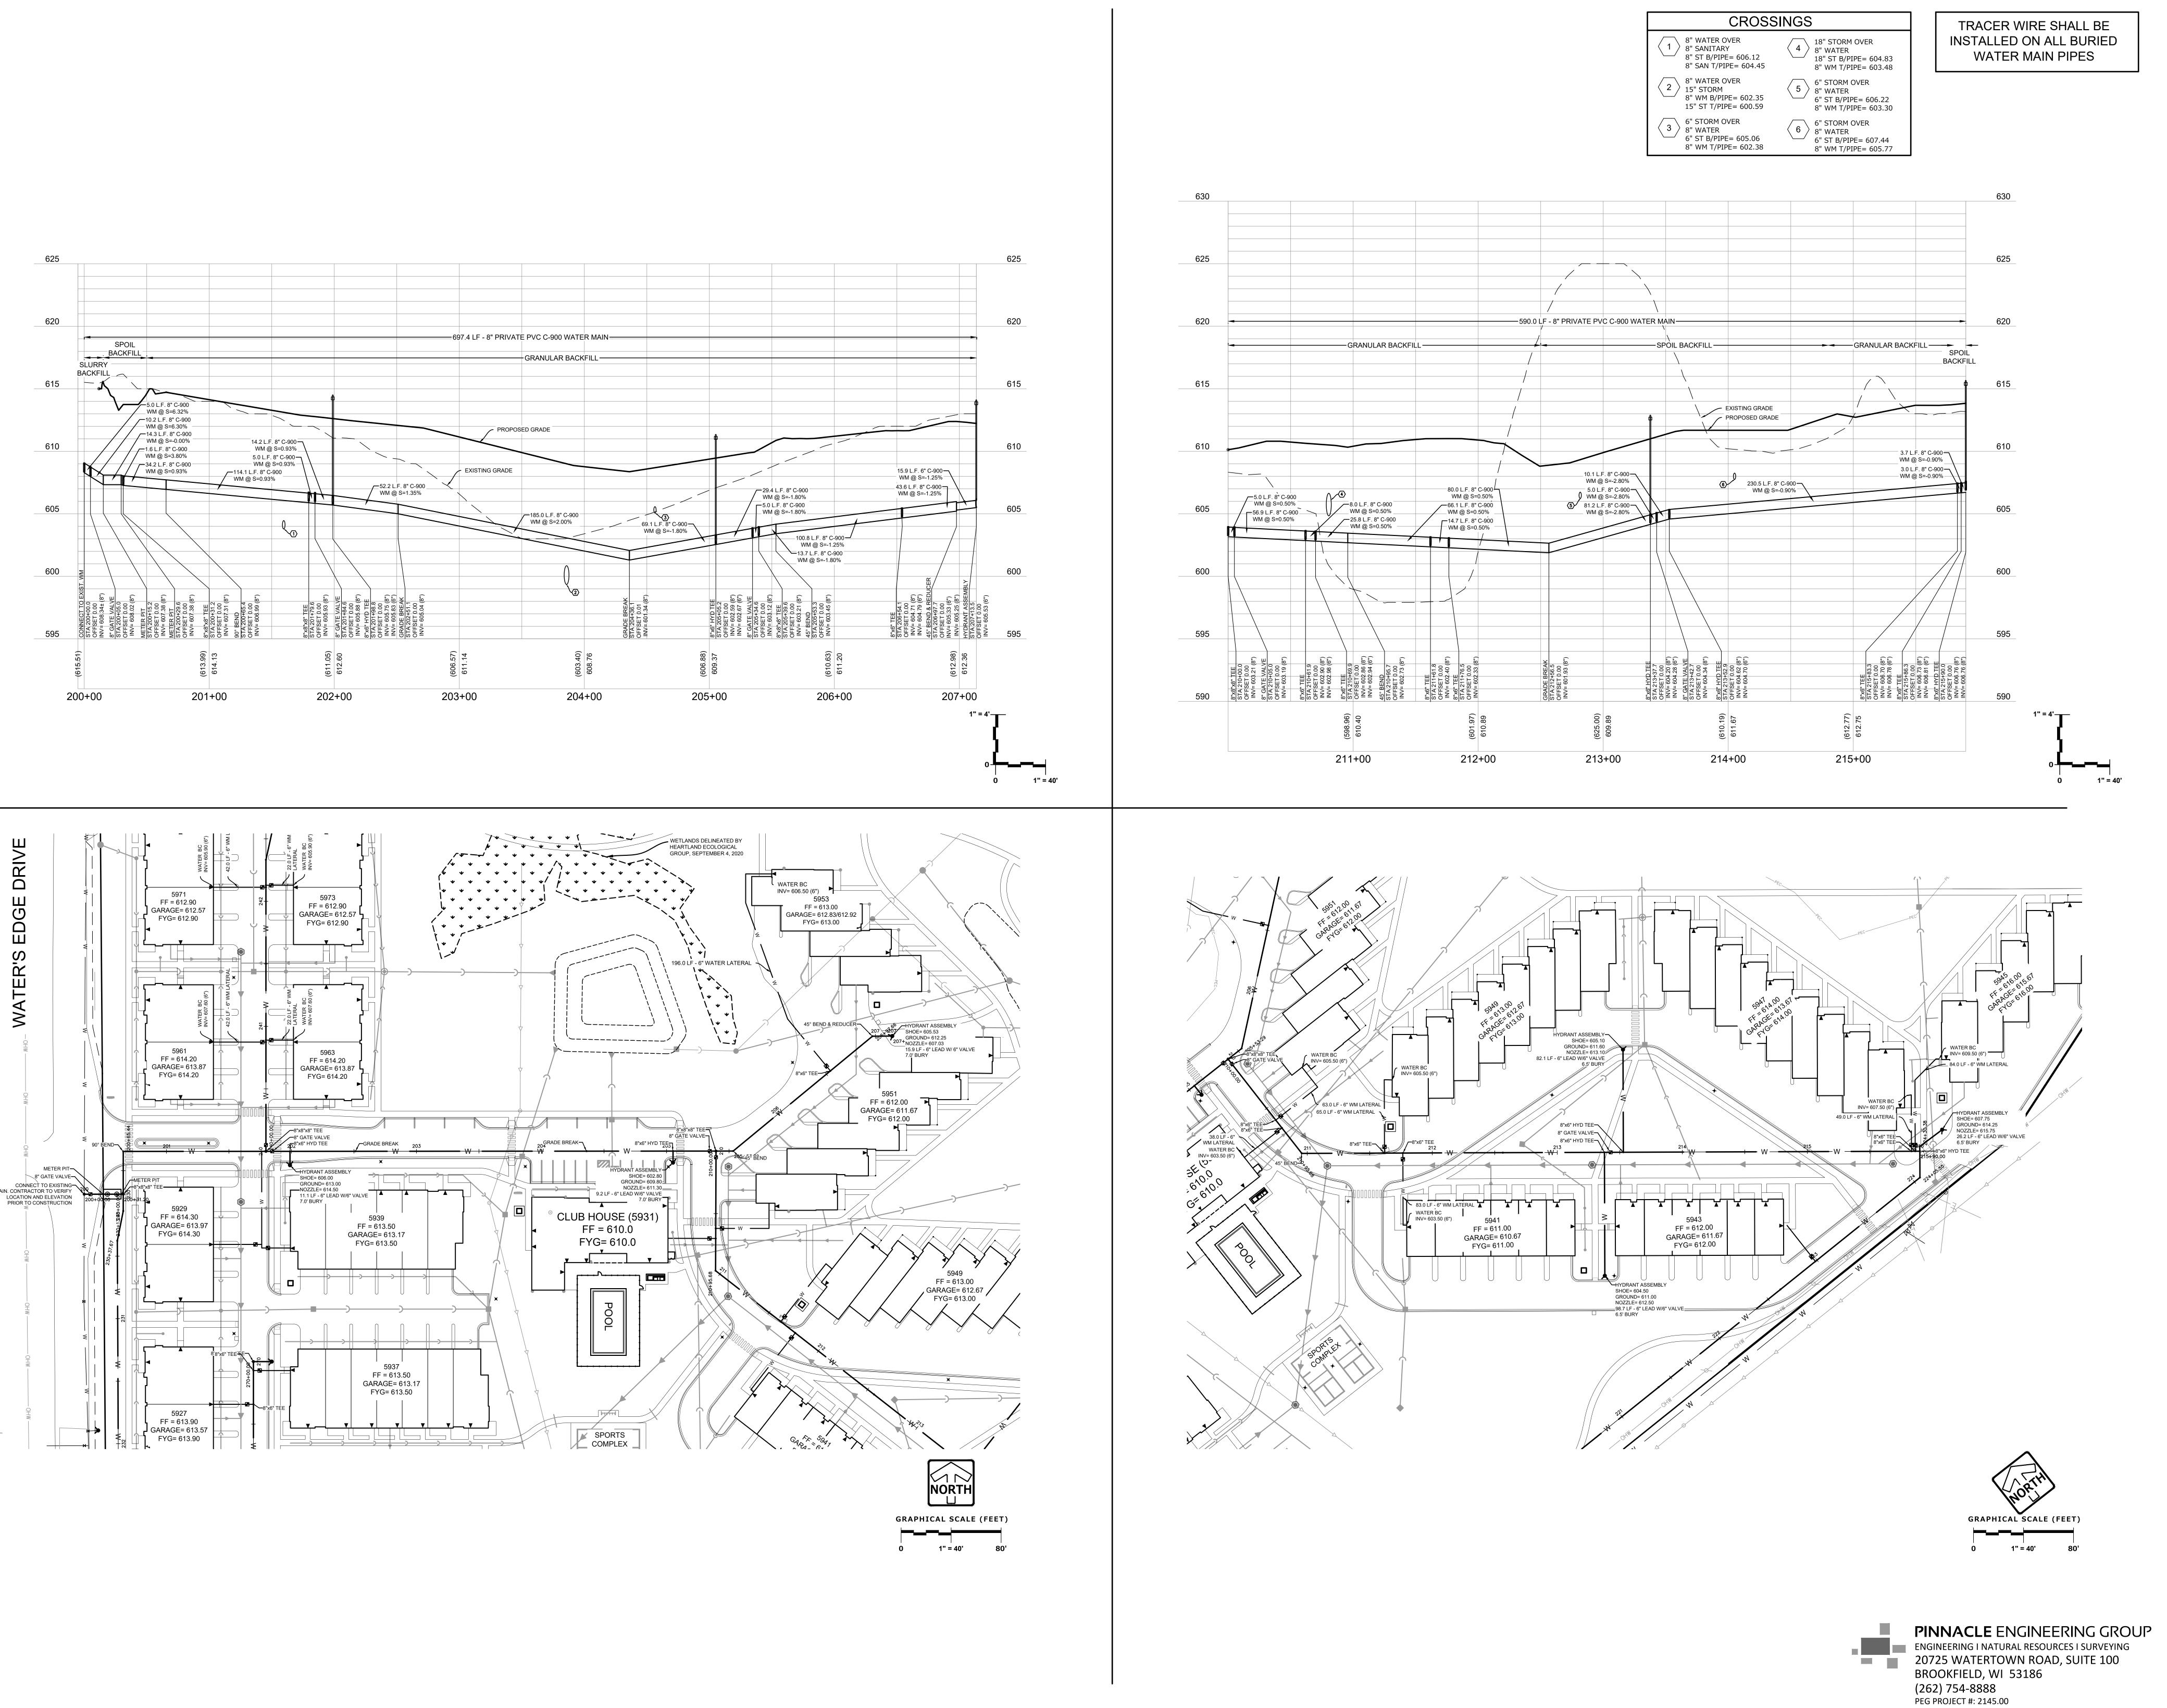

**CRINKA**756 North Milwaukee Street, Suite 250
Milwaukee, Wisconsin 53202
p 414.431.8101

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WATER'S EDGE -PHASE 1 -TOWNHOMES & CLUBHOUSE

Water's Edge Road
Caledonia, WI 53108

Date Issued: 12/12/2023

RINKA project #: 220504
Sheet Title

WATER MAIN PLAN
Sheet # C108


CROSSINGS


12" STORM OVER
8" WATER
12" ST B/PIPE= 608.02
8" WM T/PIPE= 606.03


12" STORM OVER
8" WATER
12" ST B/PIPE= 608.11
8" WM T/PIPE= 606.03


TRACER WIRE SHALL BE INSTALLED ON ALL BURIED WATER MAIN PIPES




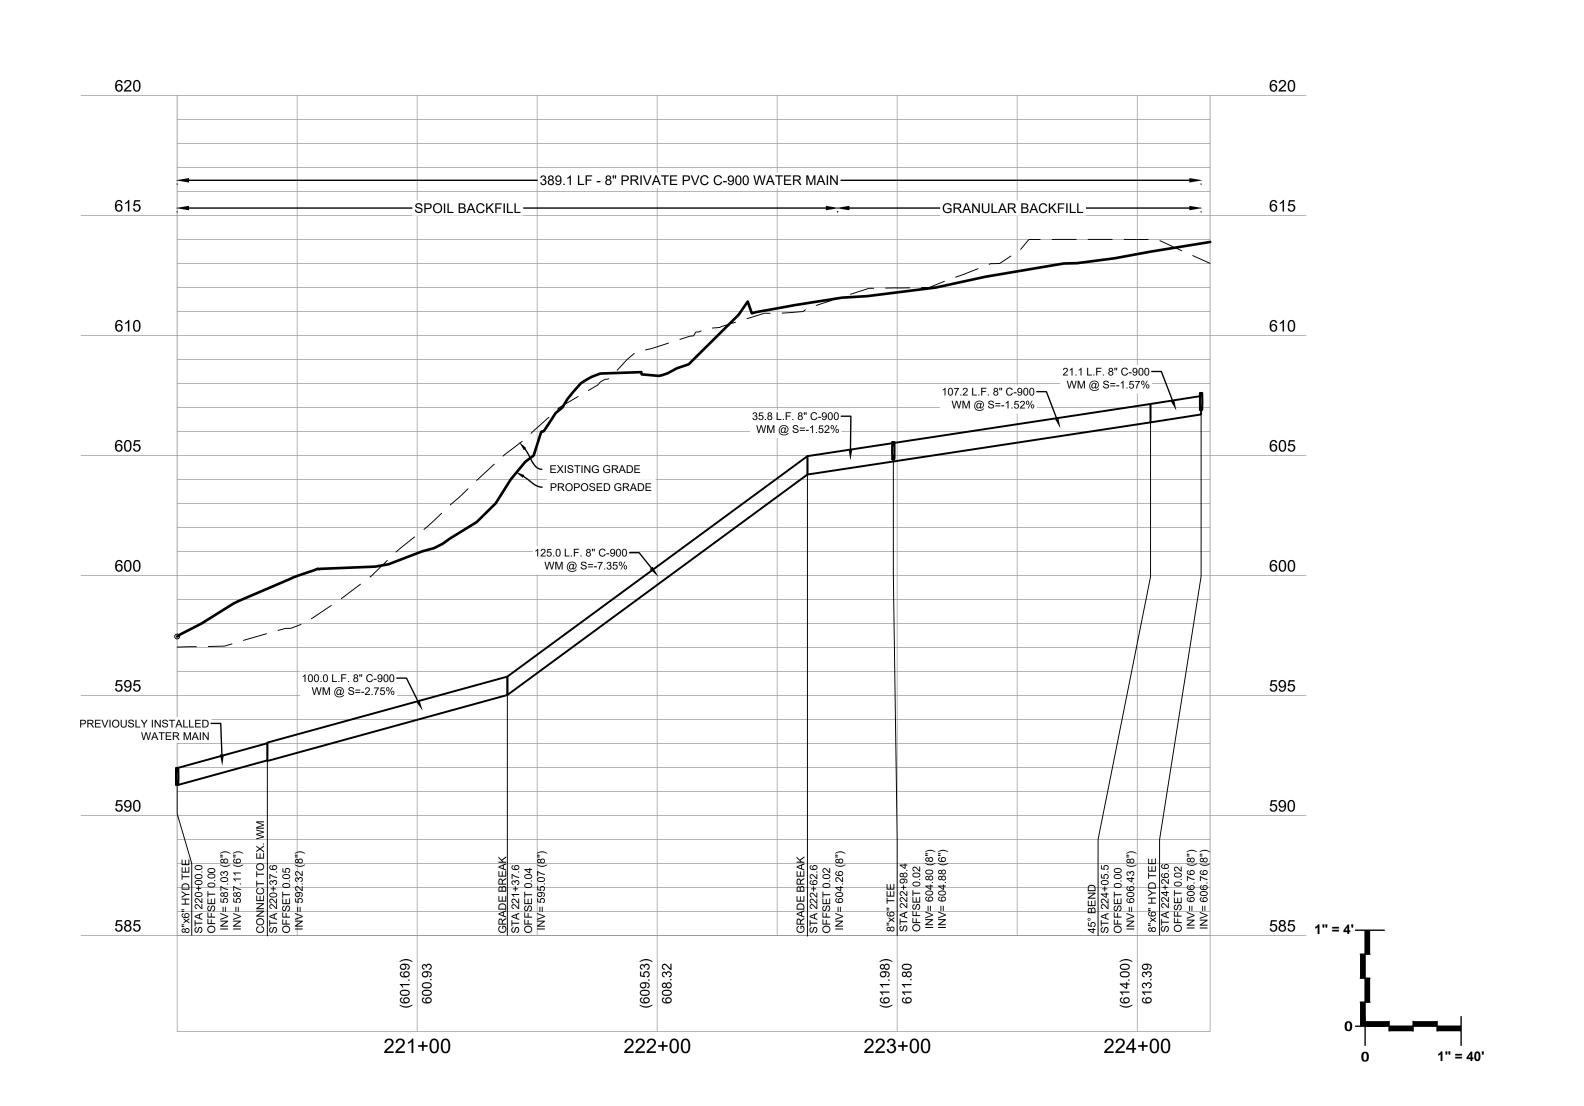

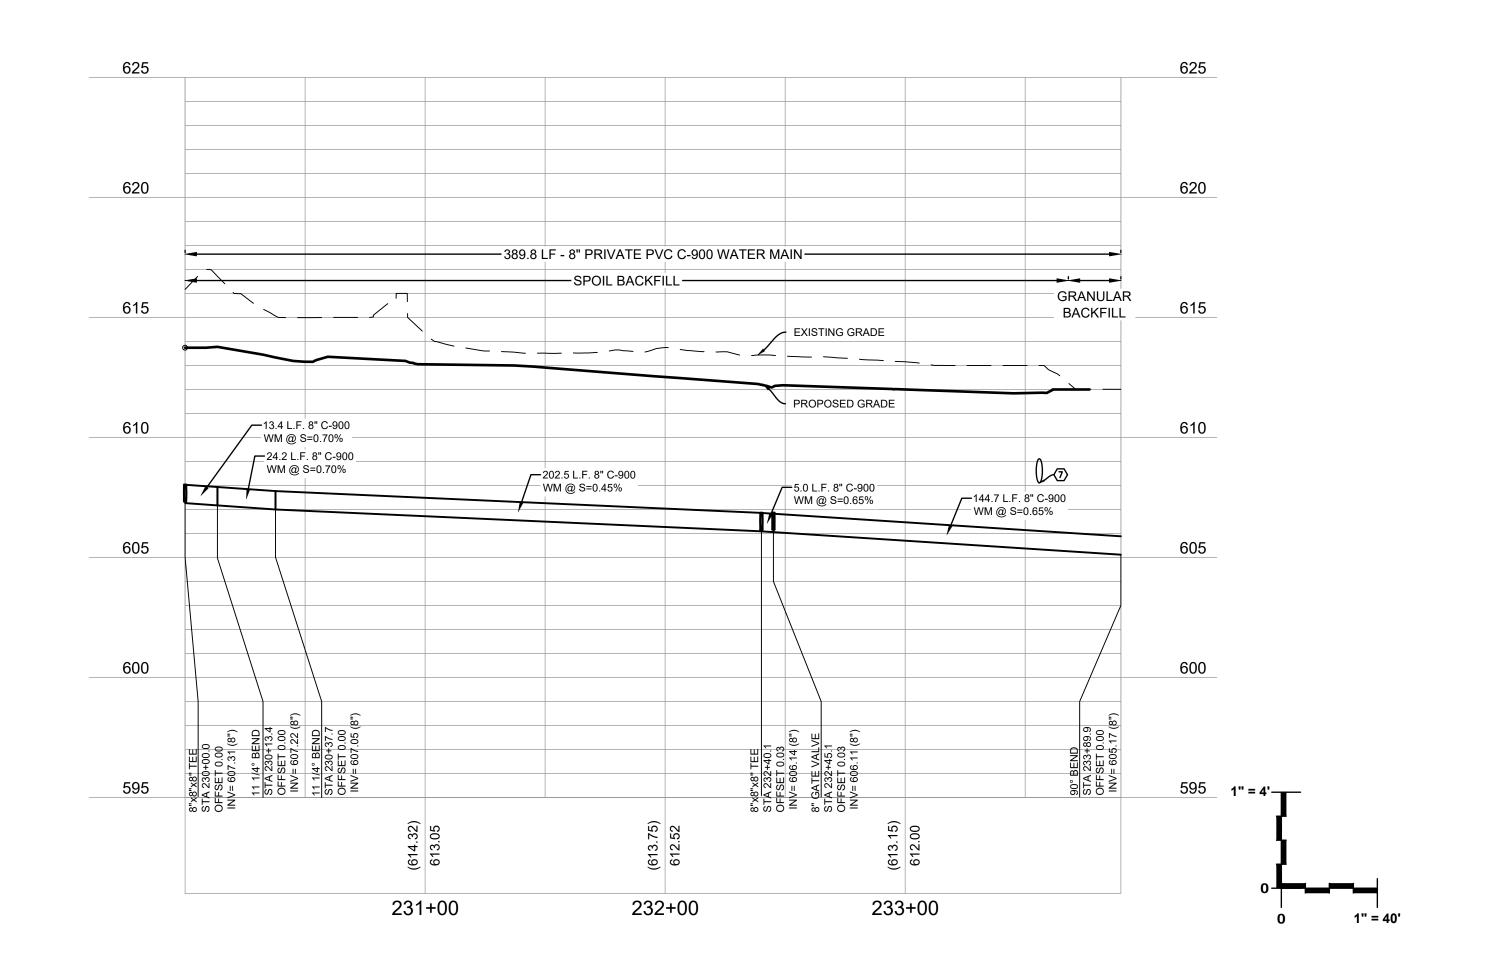

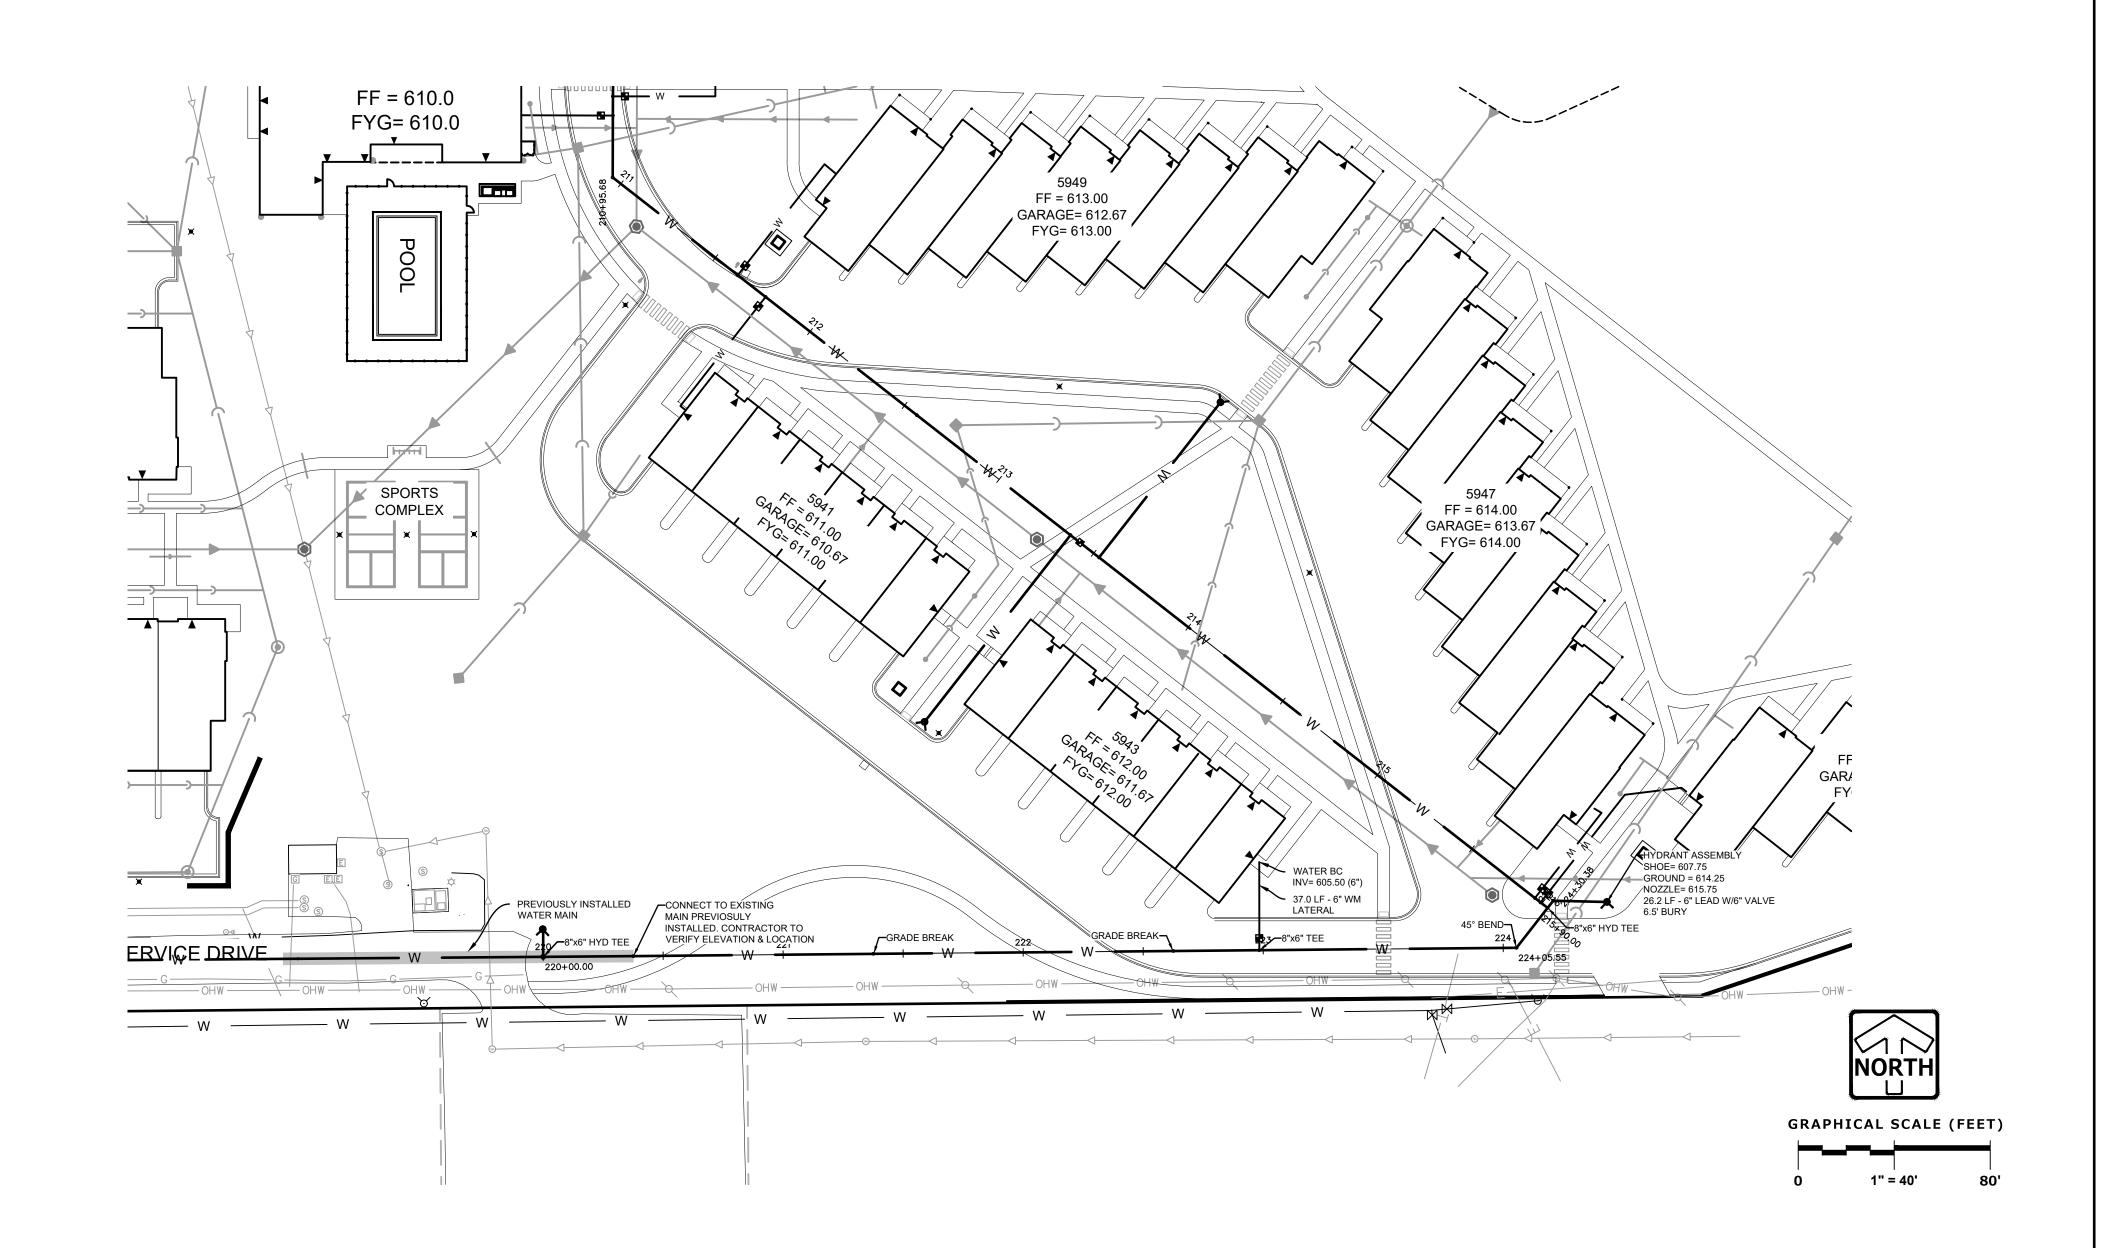

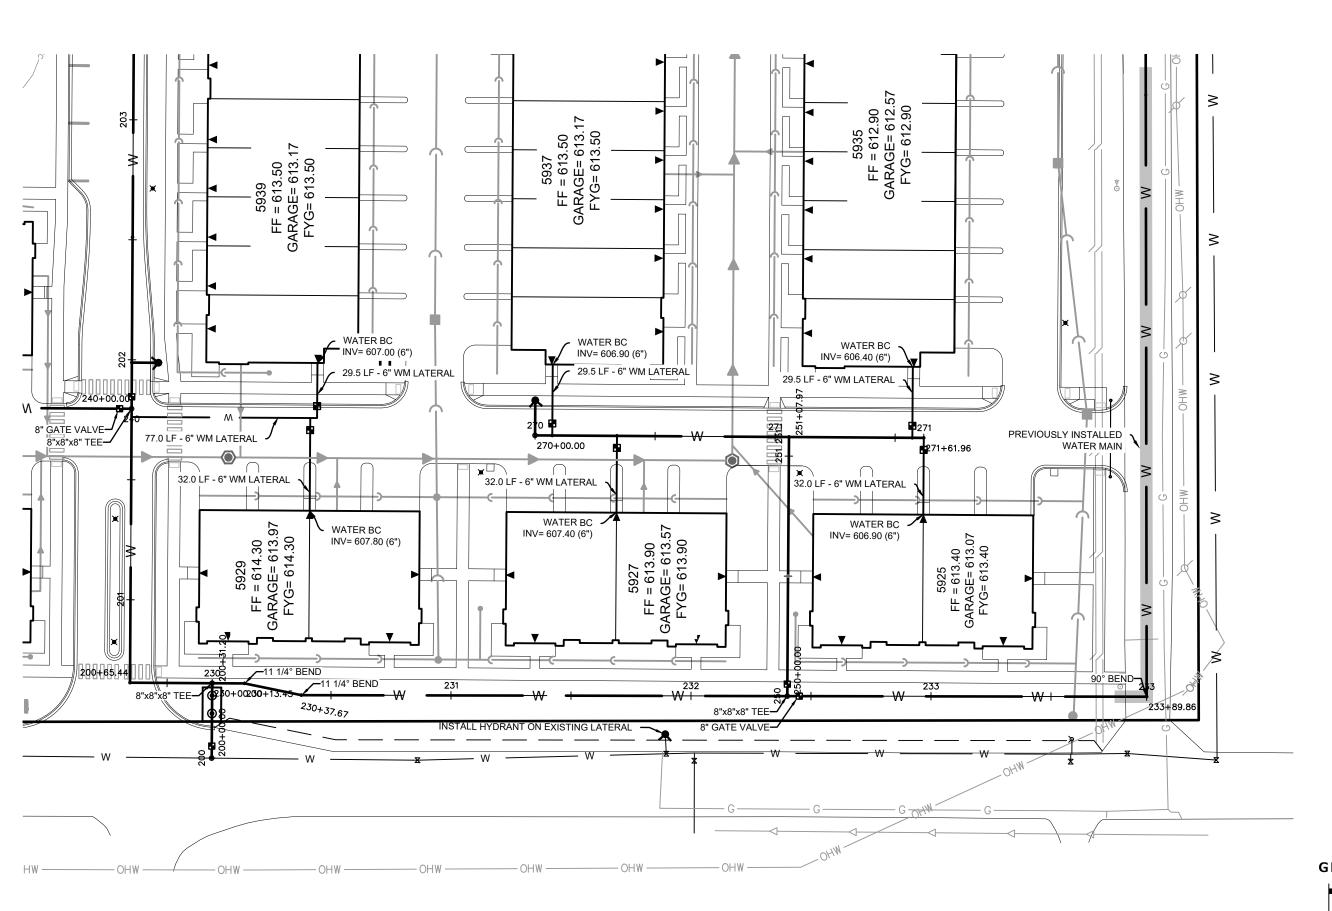

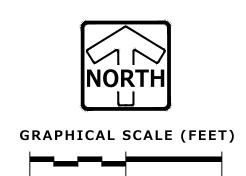

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WATER'S EDGE PHASE 1 TOWNHOMES &
CLUBHOUSE

Water's Edge Road
Caledonia, WI 53108

Date Issued: 12/12/2023

RINKA project #: 220504
Sheet Title

WATER MAIN PLAN


Sheet # C109


PINNACLE ENGINEERING GROUP
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20725 WATERTOWN ROAD, SUITE 100
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(262) 754-8888
PEG PROJECT #: 2145.00


CROSSINGS 8" WATER OVER 8" SANITARY 8" WM B/PIPE= 603.84 10" STORM OVER  $\langle 8 \rangle$  8" WATER 10" ST B/PIPE= 605.64 8" WM T/PIPE= 604.02 8" SAN T/PIPE= 602.95


TRACER WIRE SHALL BE INSTALLED ON ALL BURIED WATER MAIN PIPES




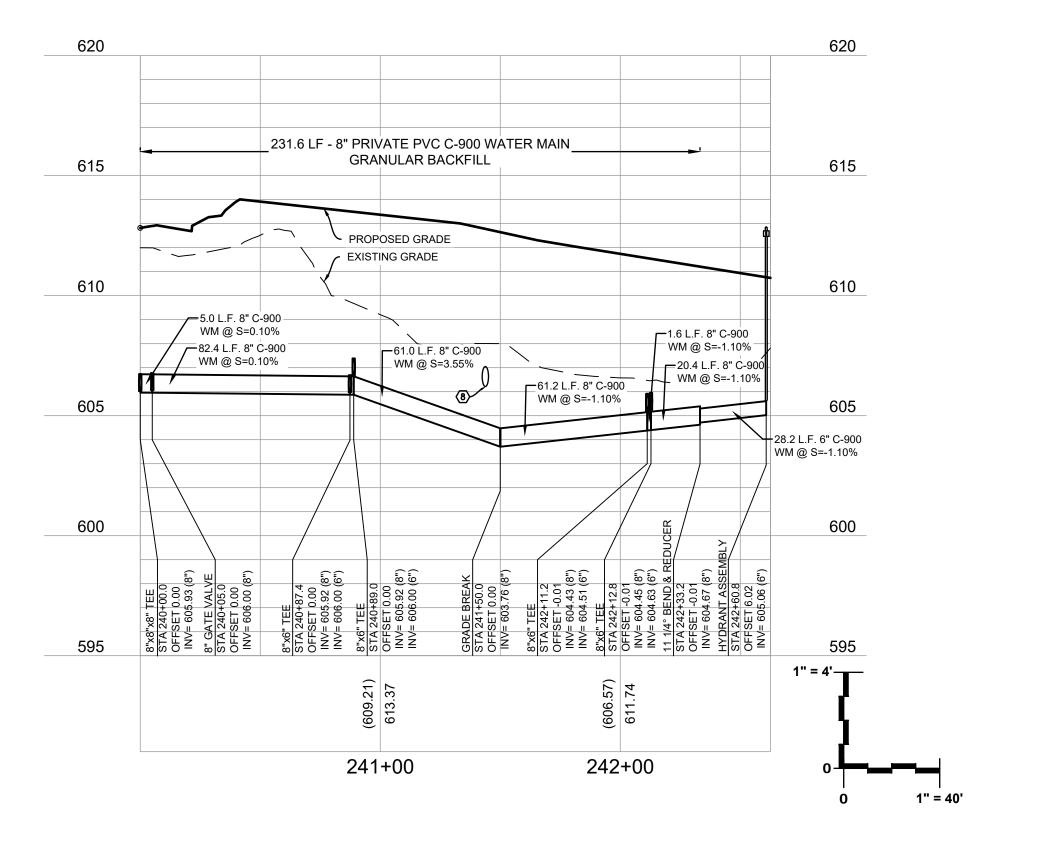


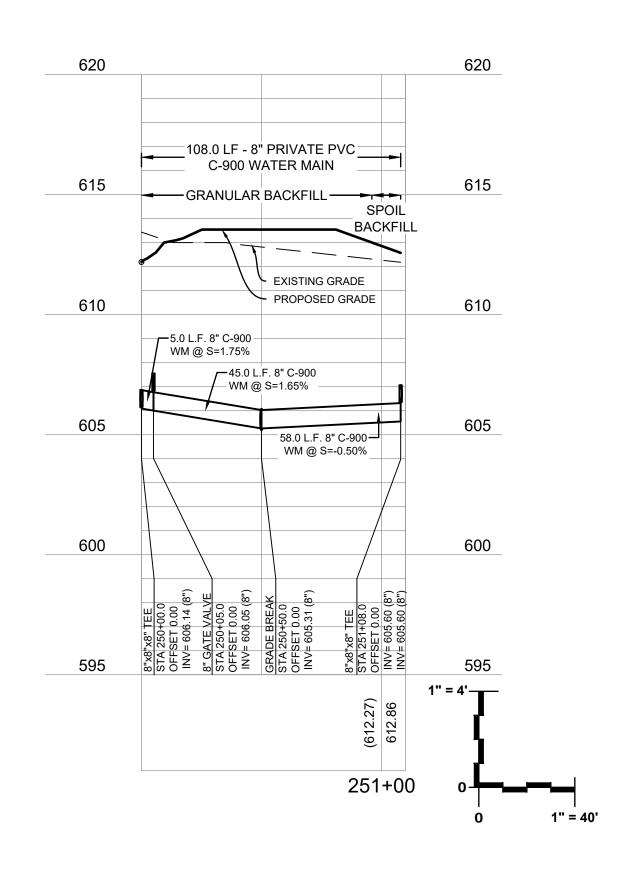


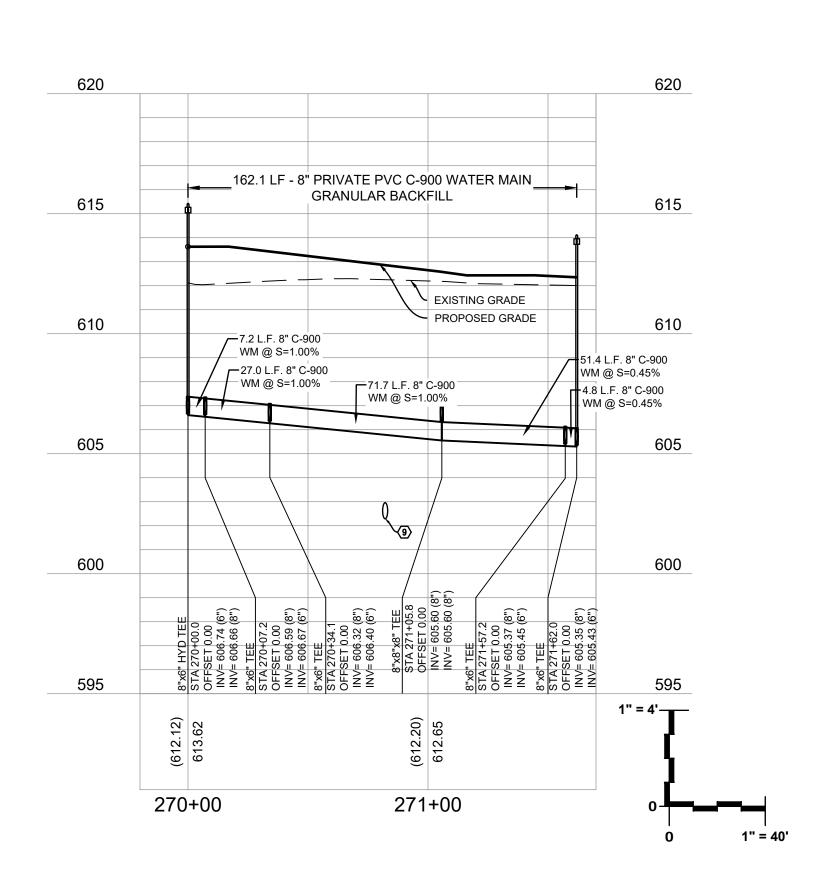

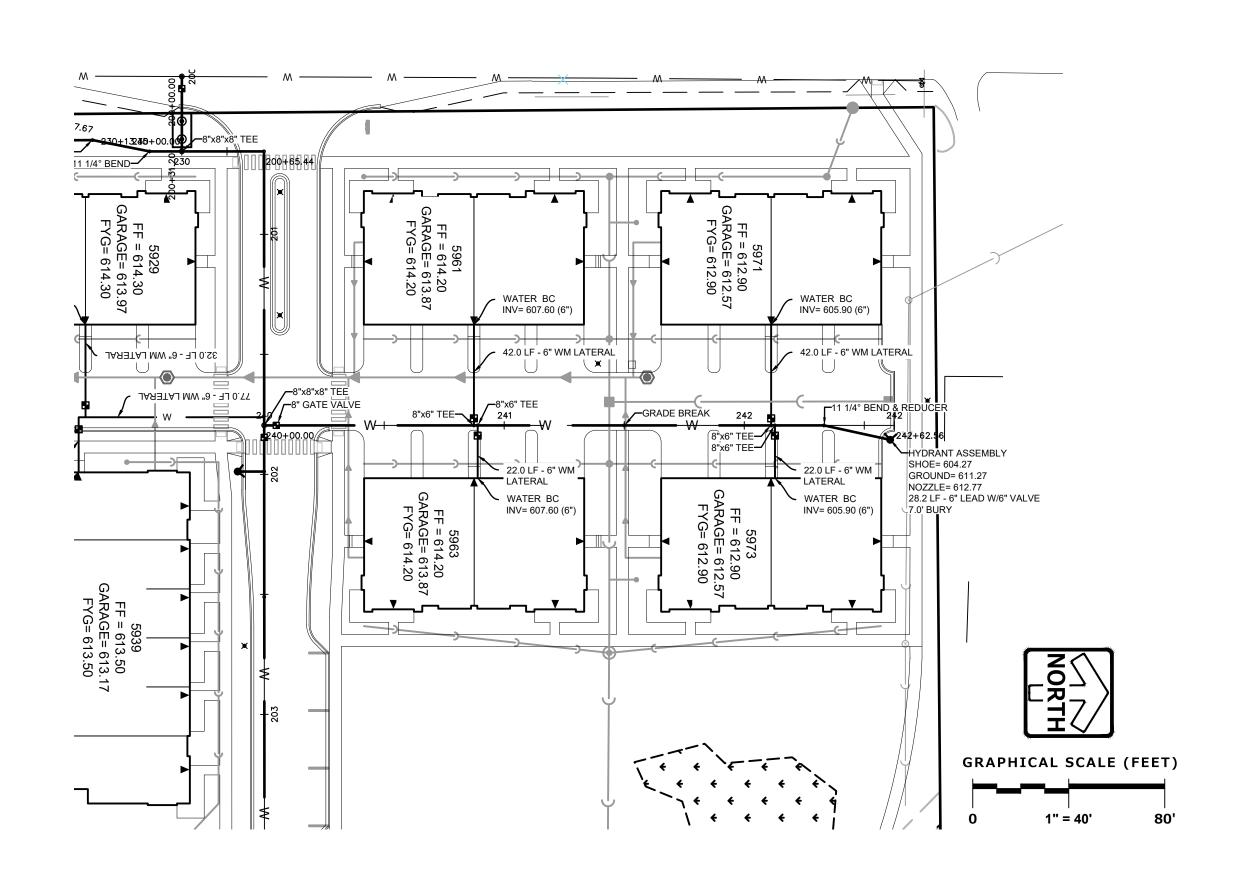

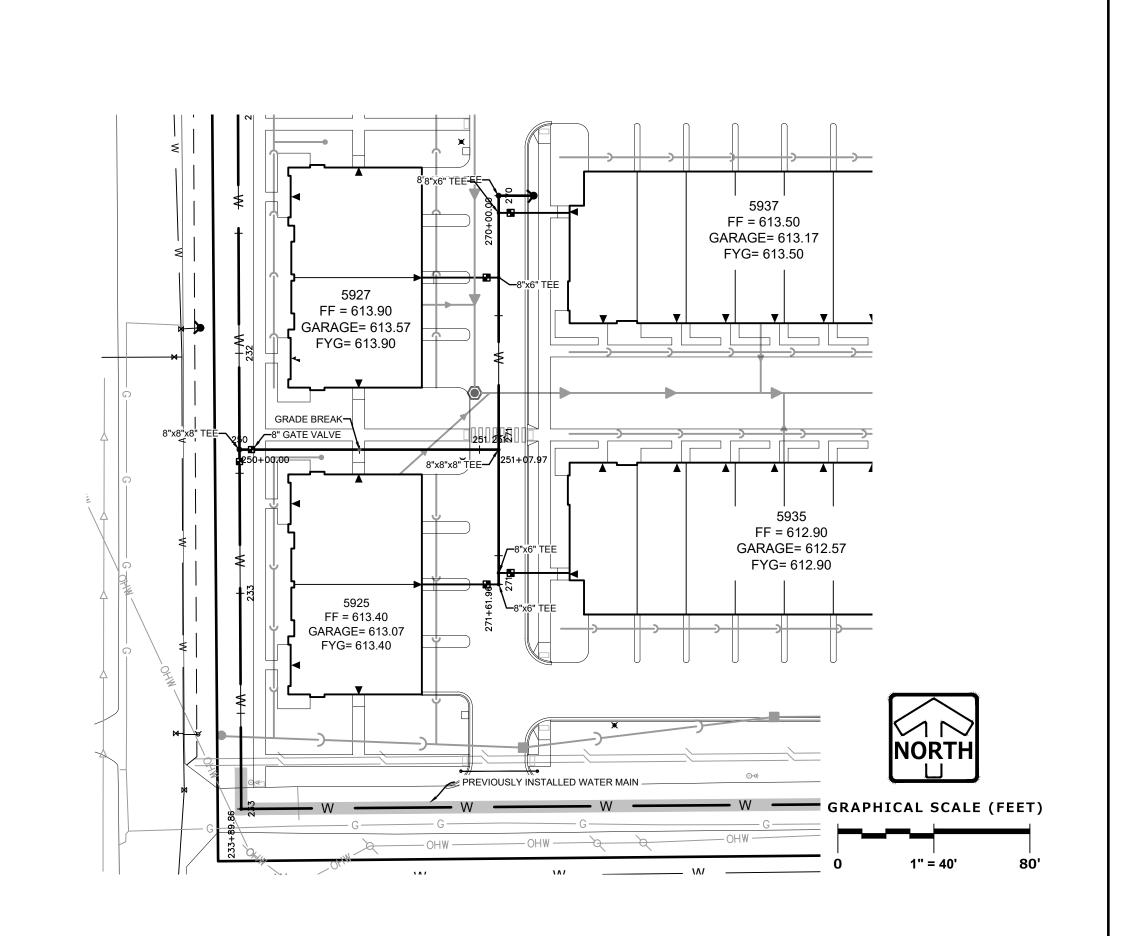

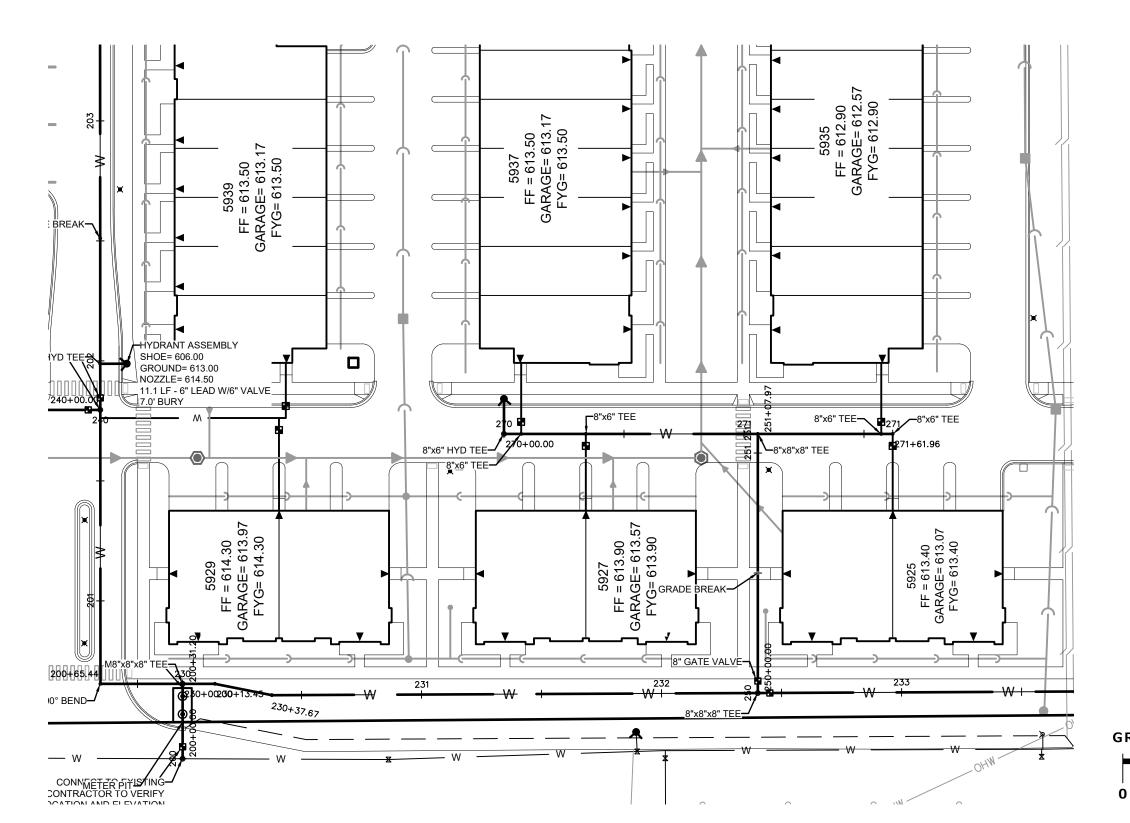

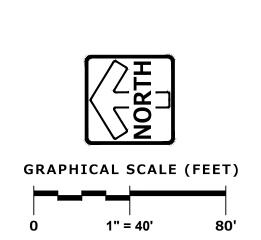



GRAPHICAL SCALE (FEET)



PINNACLE ENGINEERING GROUP
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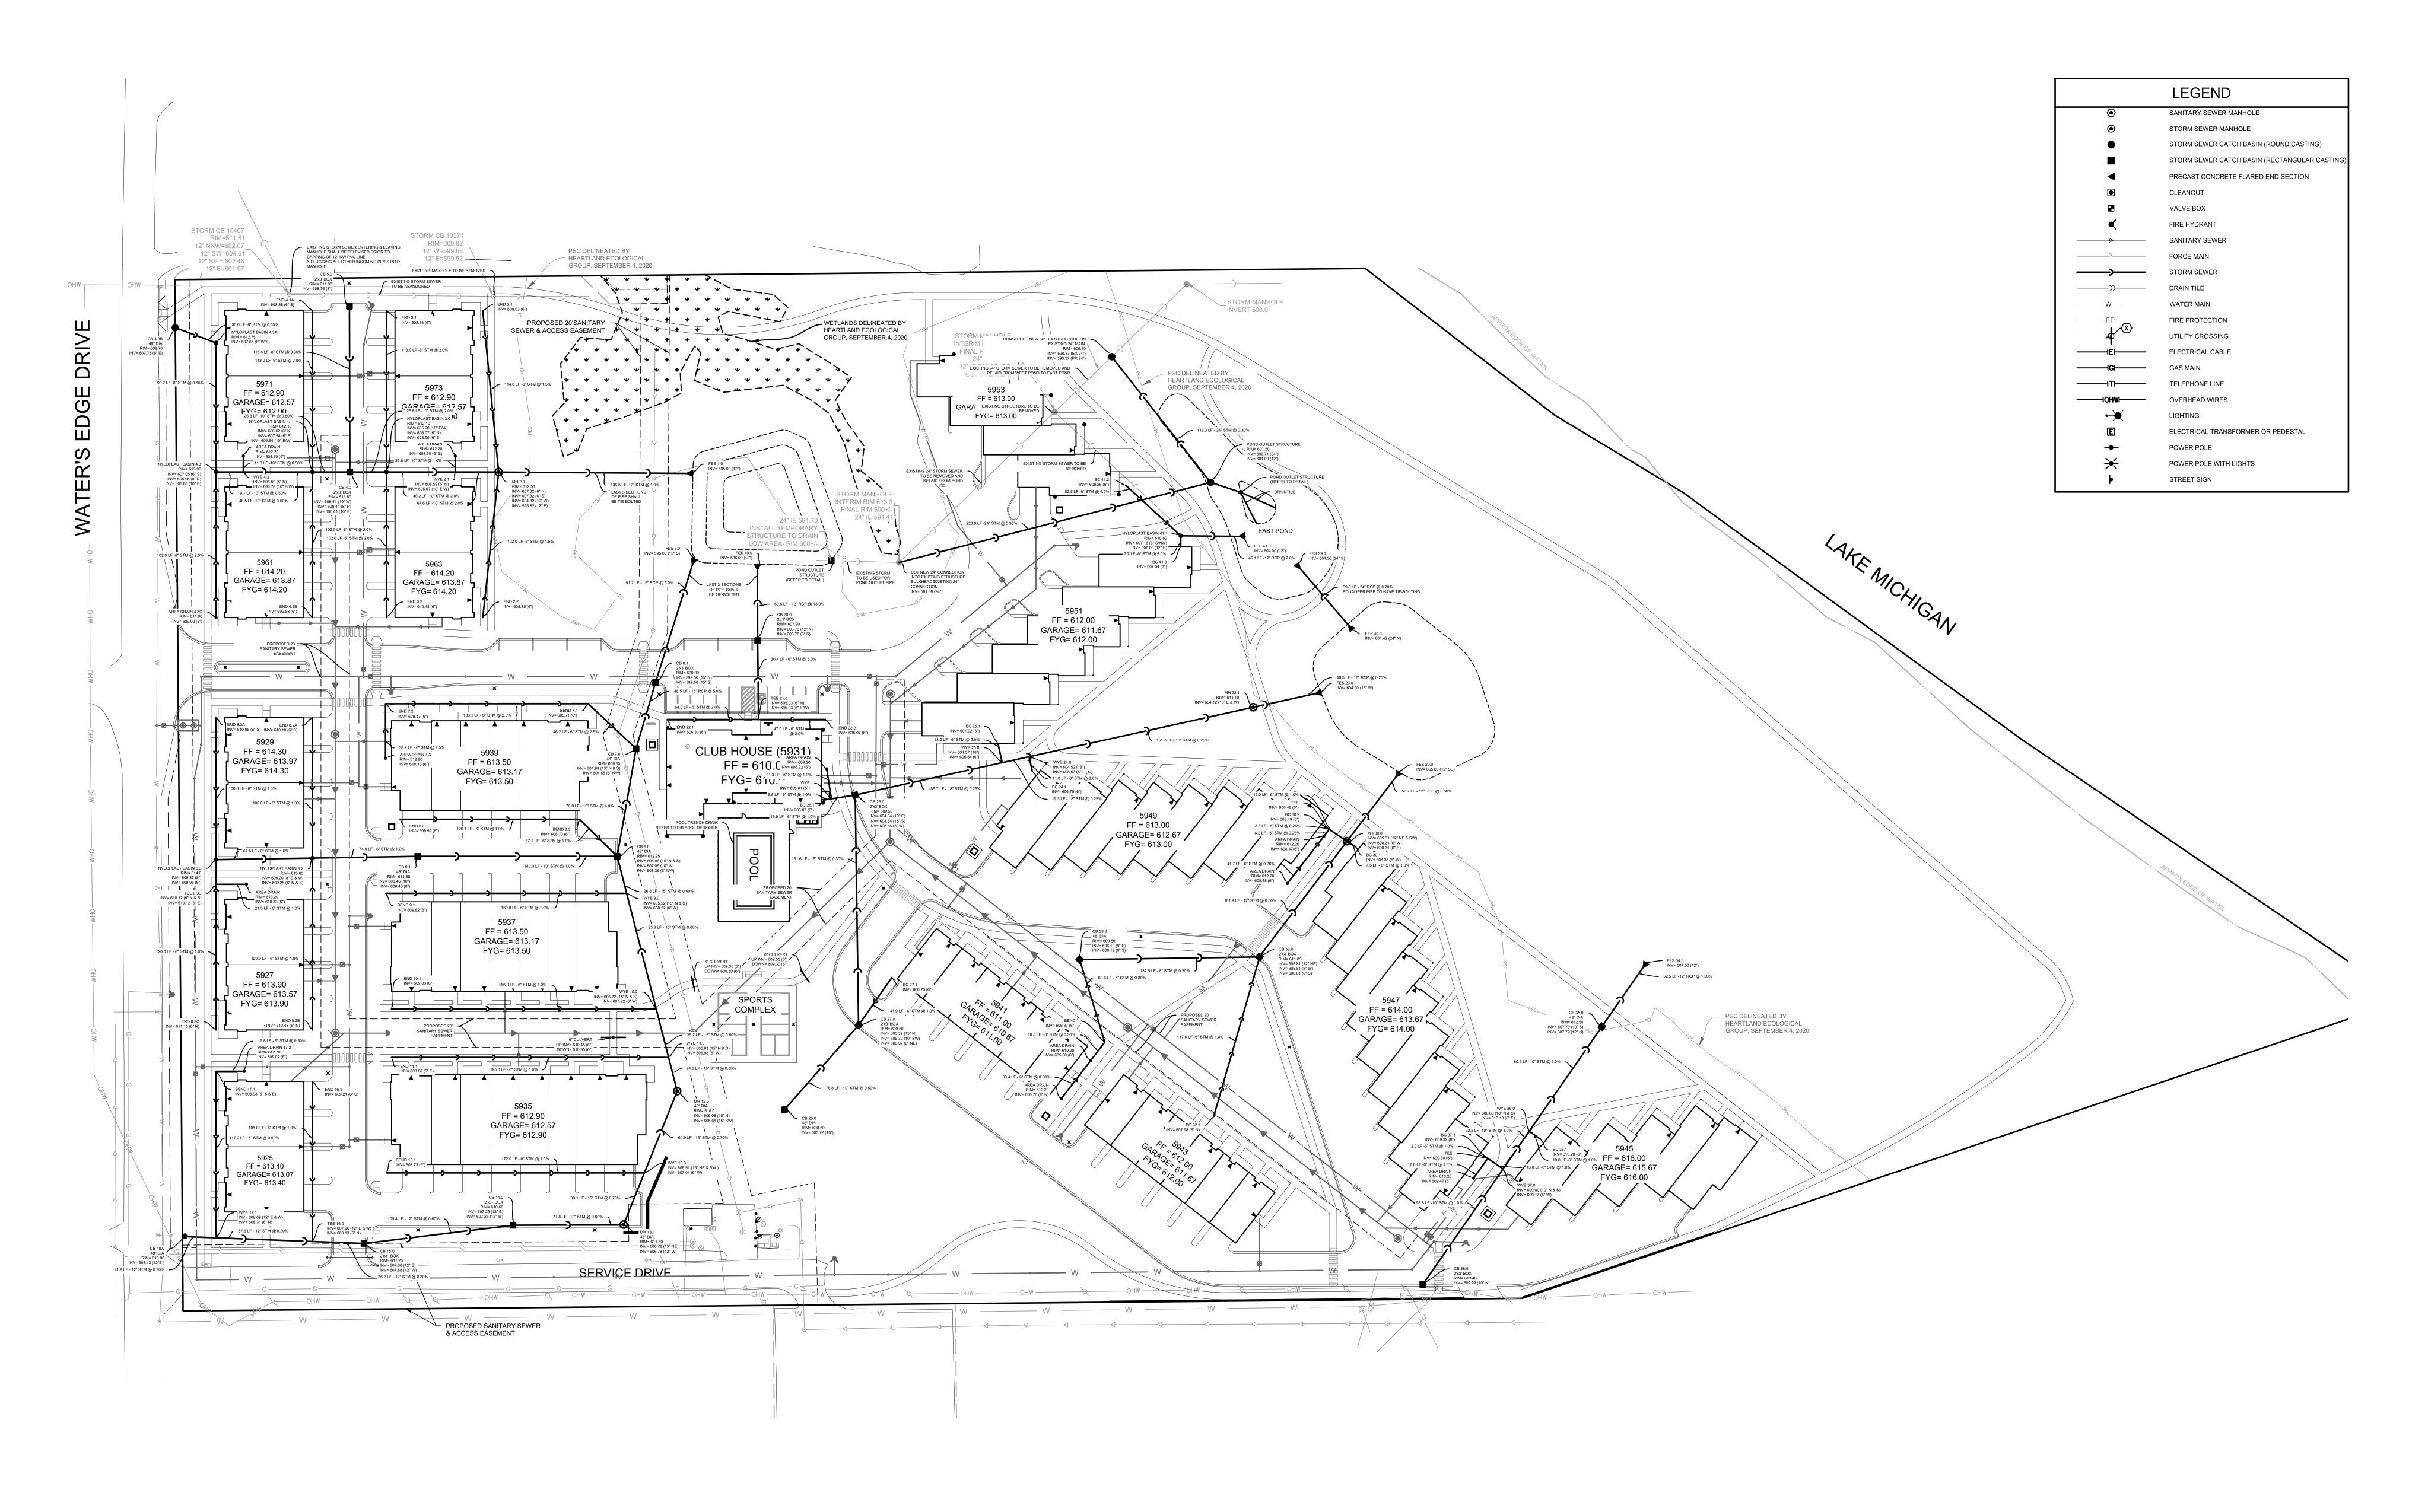
100% CONSTRUCTION DOCUMENTS

WATER'S EDGE -PHASE 1 -TOWNHOMES & CLUBHOUSE

Water's Edge Road Caledonia, WI 53108 Date Issued: 12/12/2023 RINKA project #: 220504 Sheet Title

WATER MAIN PLAN Sheet # C110







**PINNACLE** ENGINEERING GROUP ENGINEERING I NATURAL RESOURCES I SURVEYING 20725 WATERTOWN ROAD, SUITE 100 BROOKFIELD, WI 53186 (262) 754-8888 PEG PROJECT #: 2145.00

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WATER'S EDGE -PHASE 1 -TOWNHOMES & CLUBHOUSE

Water's Edge Road Caledonia, WI 53108 Date Issued: 12/12/2023

RINKA project #: 220504

Sheet Title

Sheet #

STORM SEWER PLAN

C111




**LEGEND** 

HEAVY DUTY PAVEMENT
- SEE CONSTRUCTION DETAIL

LIGHT DUTY PAVEMENT

CONCRETE SIDEWALK
- SEE CONSTRUCTION DETAIL

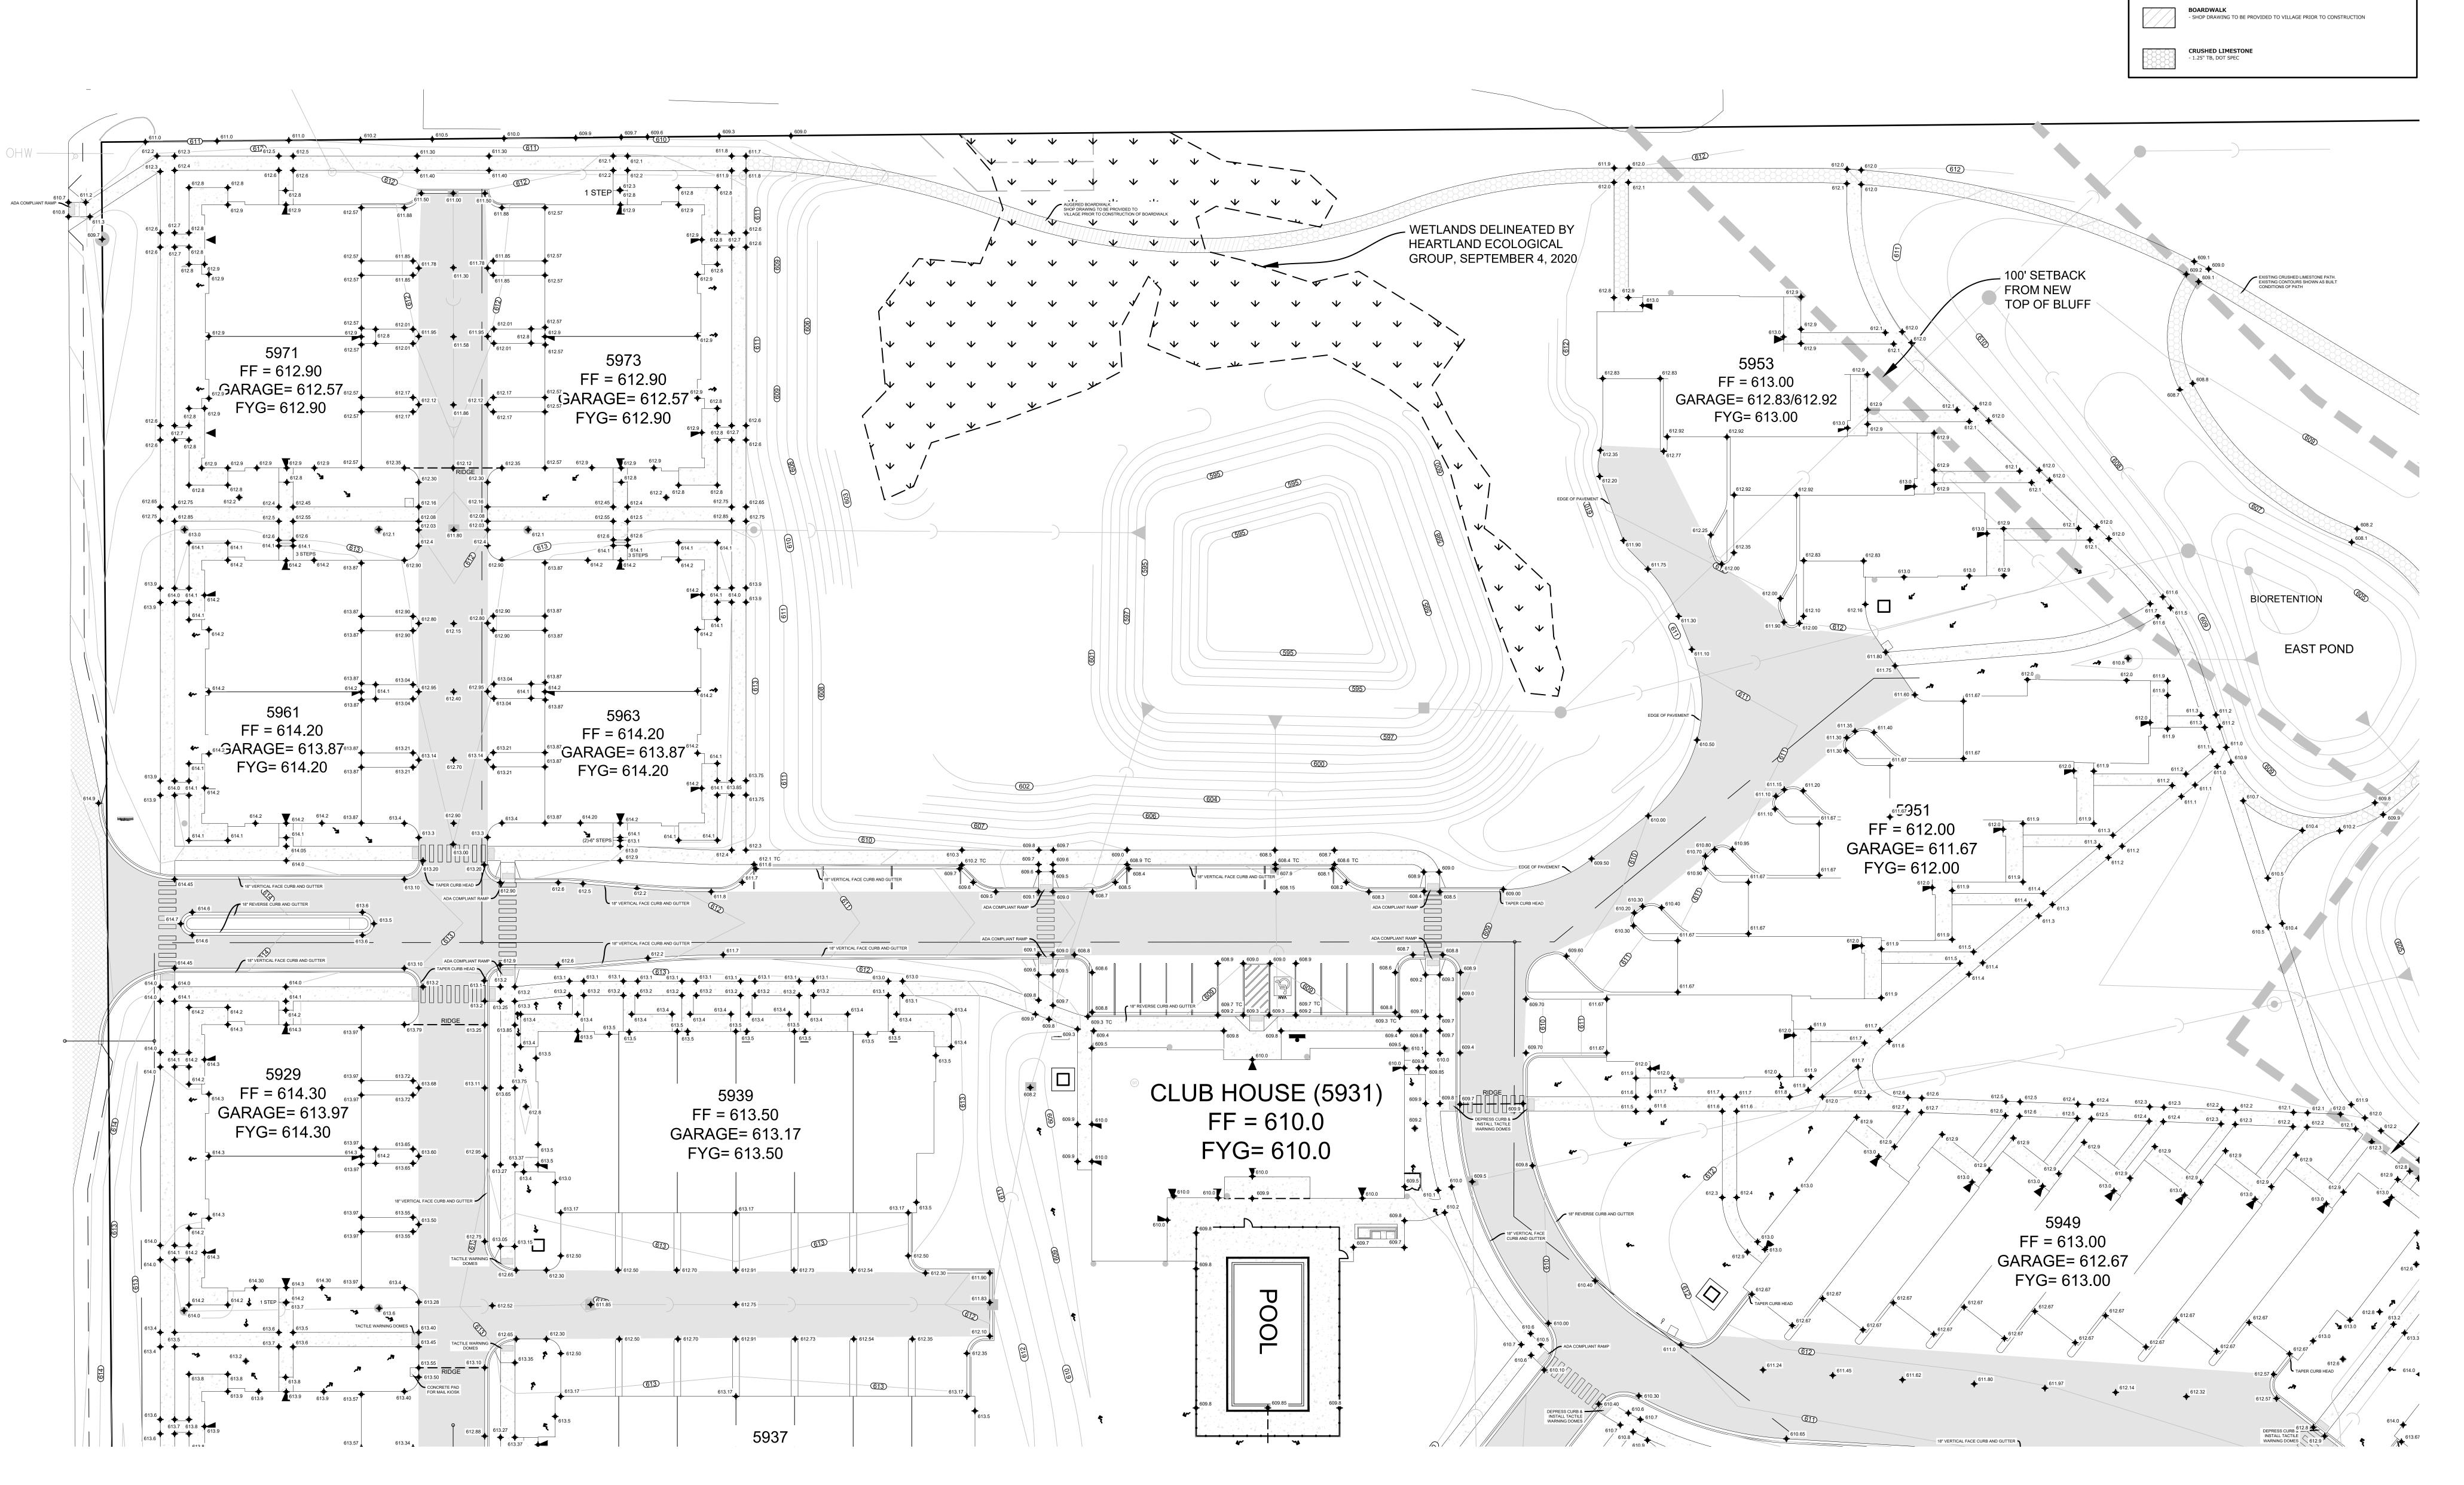

WATER'S EDGE -PHASE 1 -TOWNHOMES & CLUBHOUSE

100%

CONSTRUCTION

DOCUMENTS

Water's Edge Road
Caledonia, WI 53108

Date Issued: 12/12/2023


RINKA project #: 220504
Sheet Title

riangle Revisions

PINNACLE ENGINEERING GROUP
ENGINEERING I NATURAL RESOURCES I SURVEYING
20725 WATERTOWN ROAD, SUITE 100
BROOKFIELD, WI 53186
(262) 754-8888
PEG PROJECT #: 2145.00

PAVING PLAN
Sheet #
C112

**GRAPHICAL SCALE (FEET)** 

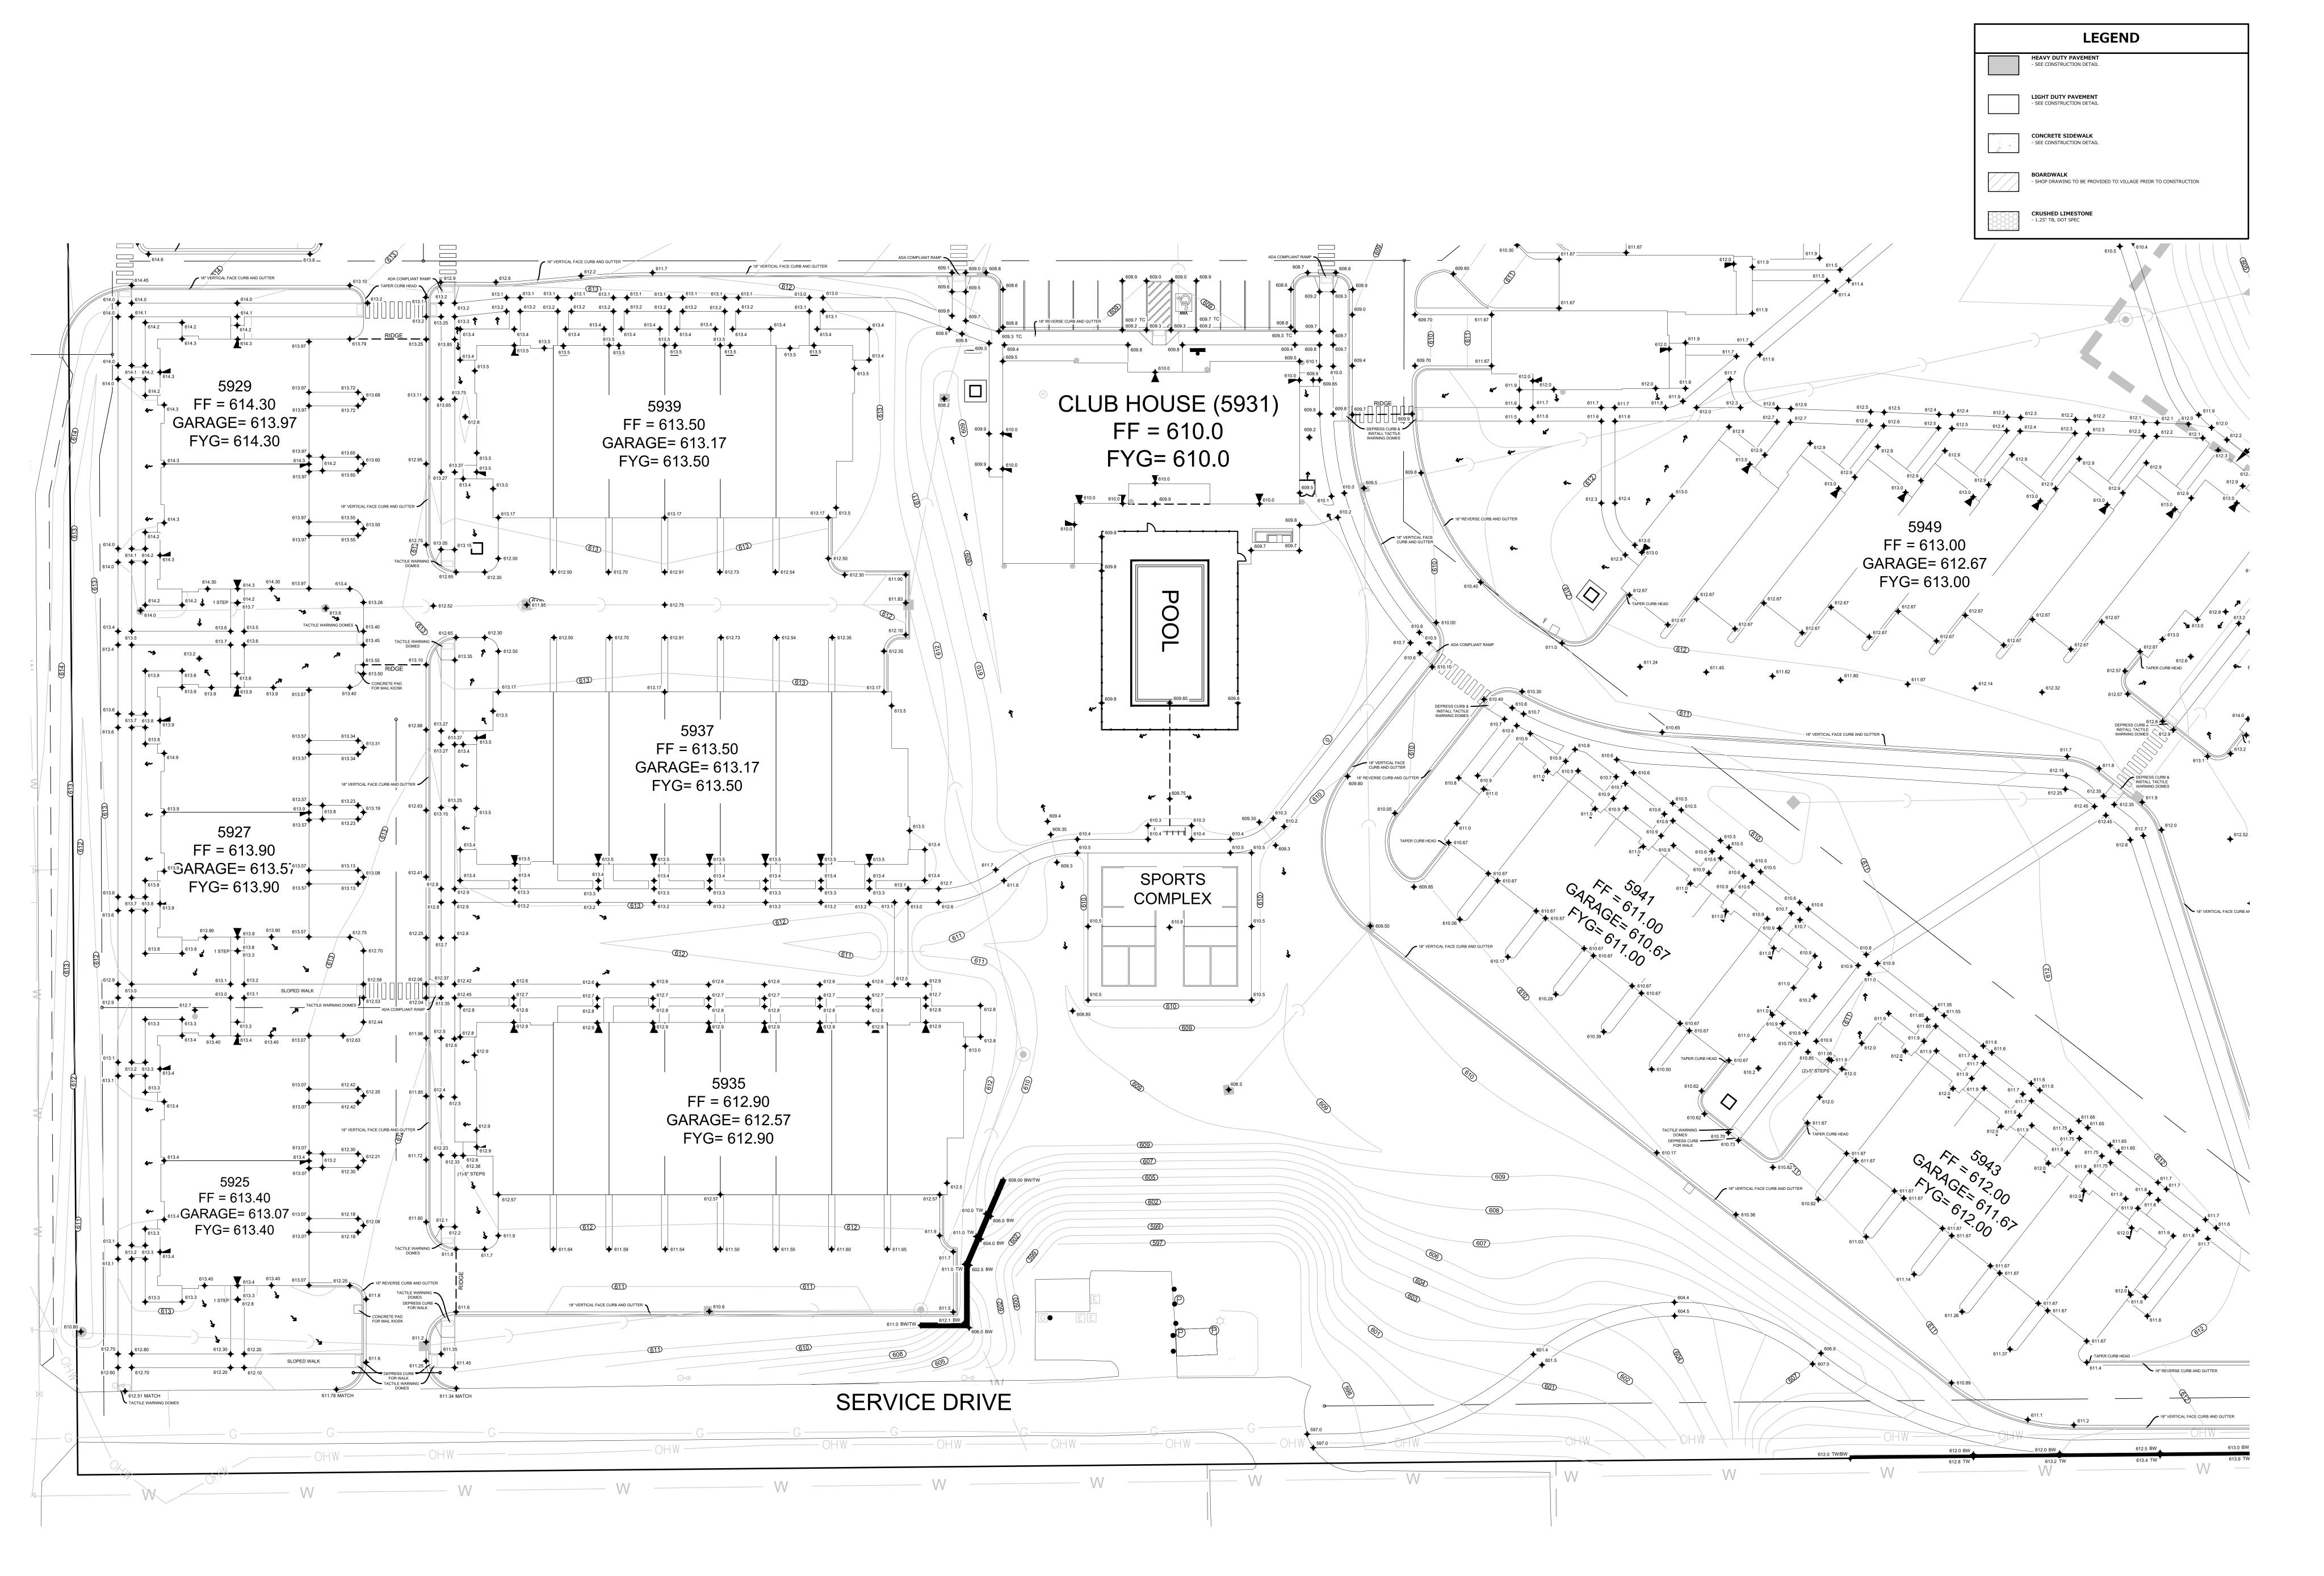



GRAPHICAL SCALE (FEET)

**PINNACLE** ENGINEERING GROUP ENGINEERING I NATURAL RESOURCES I SURVEYING 20725 WATERTOWN ROAD, SUITE 100 BROOKFIELD, WI 53186 (262) 754-8888 PEG PROJECT #: 2145.00

riangle Revisions

100% CONSTRUCTION **DOCUMENTS** 

WATER'S EDGE -PHASE 1 -TOWNHOMES & CLUBHOUSE


Water's Edge Road Caledonia, WI 53108 Date Issued: 12/12/2023 RINKA project #: 220504 Sheet Title


**PAVING PLAN** 

Sheet # C113

Sheet #

C114

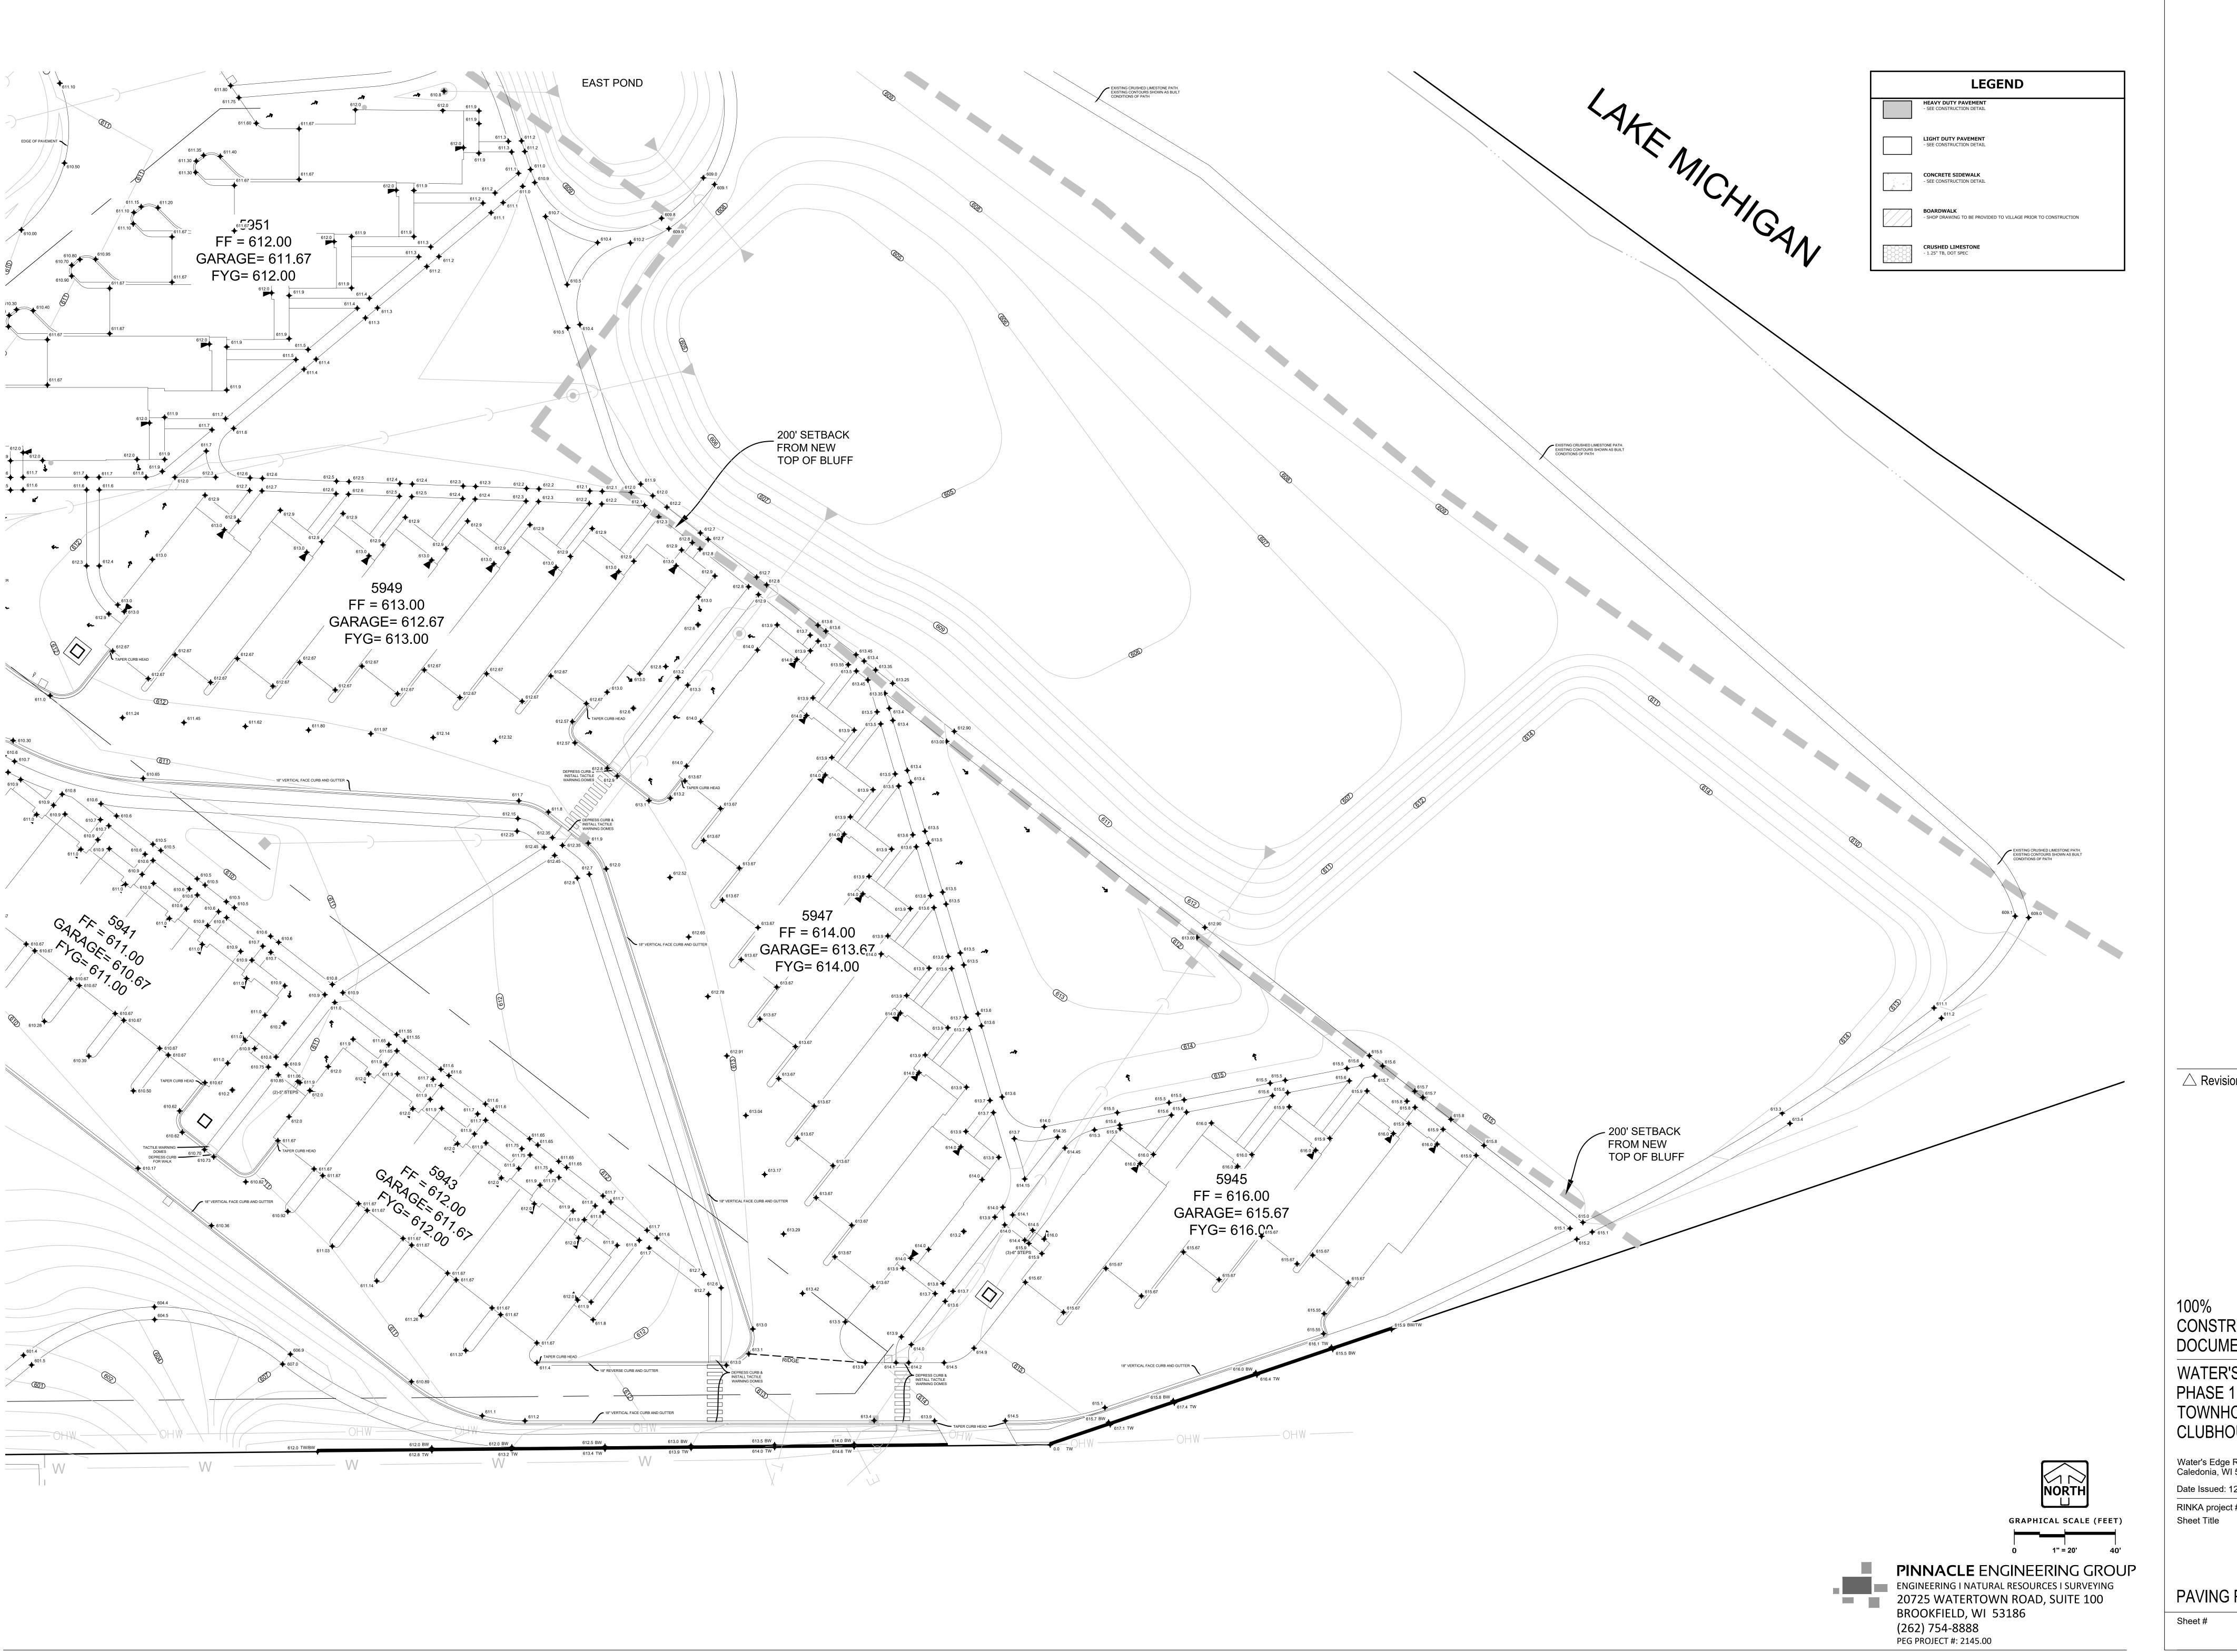

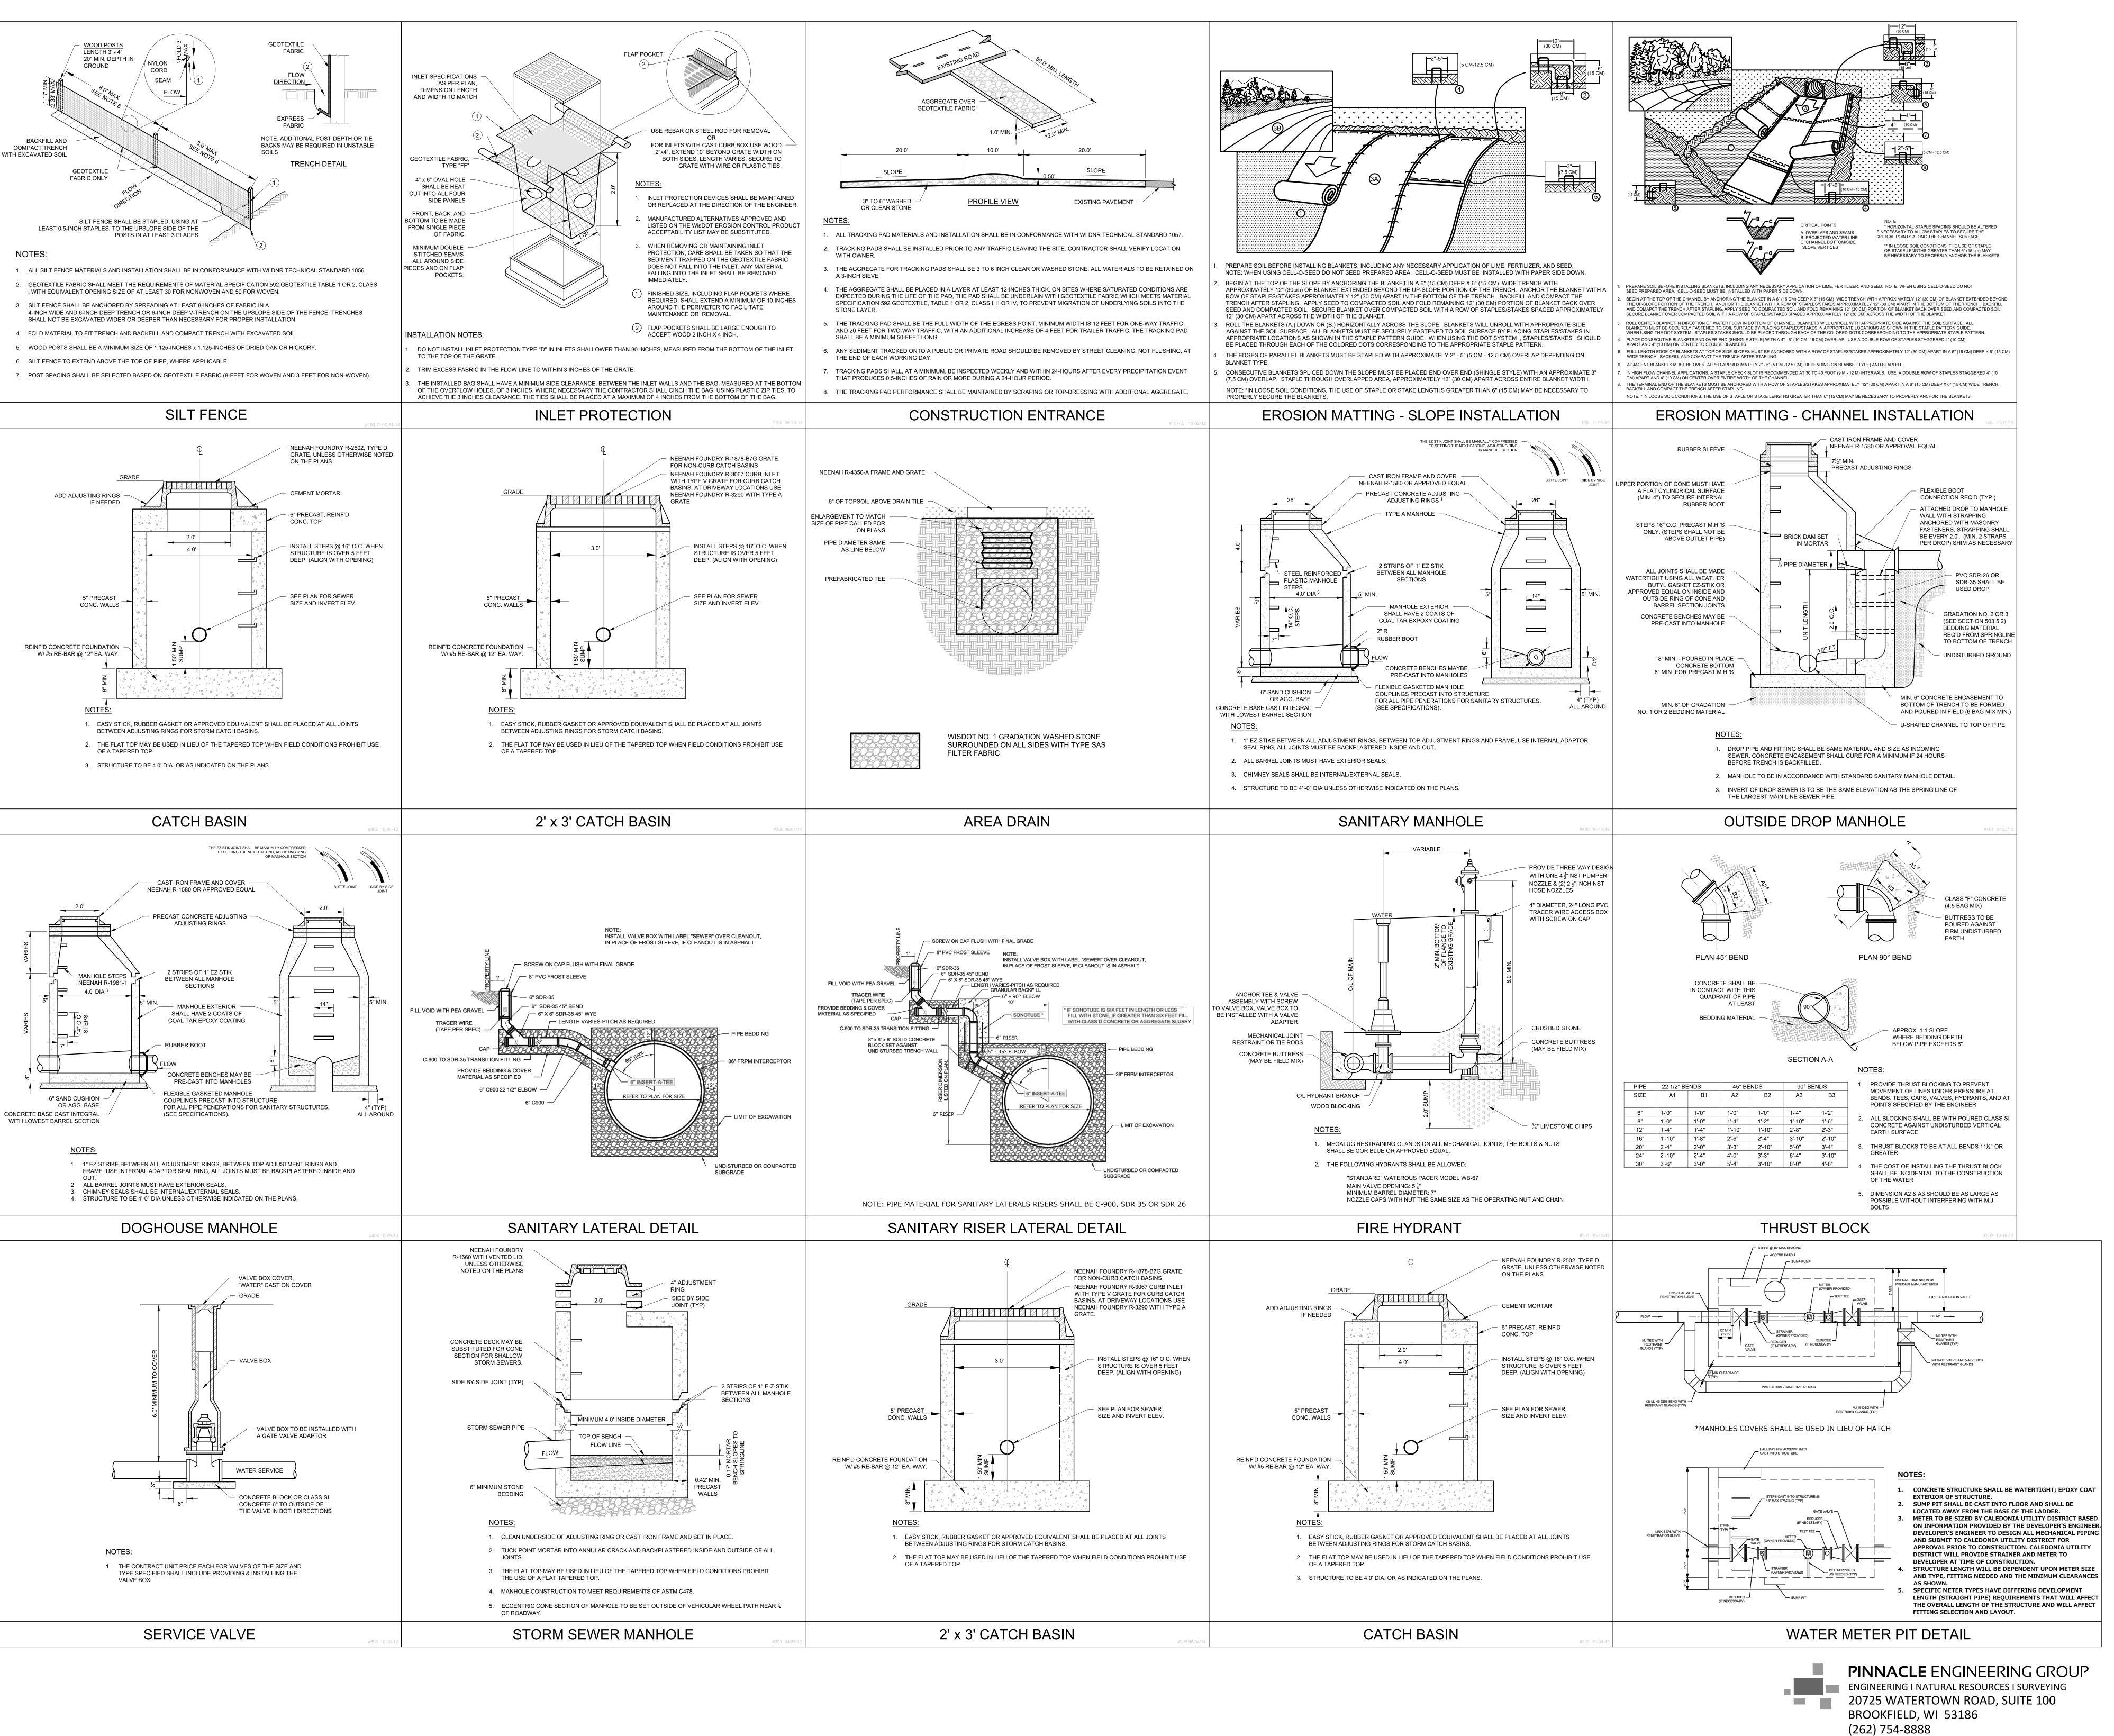



\_\_\_\_\_\_ Revisions

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WATER'S EDGE PHASE 1 -


PHASE 1 -TOWNHOMES & CLUBHOUSE

Water's Edge Road Caledonia, WI 53108 Date Issued: 12/12/2023 RINKA project #: 220504 Sheet Title

CONSTRUCTION
DETAILS &
SPECIFICATIONS

Sheet #

PEG PROJECT #: 2145.00

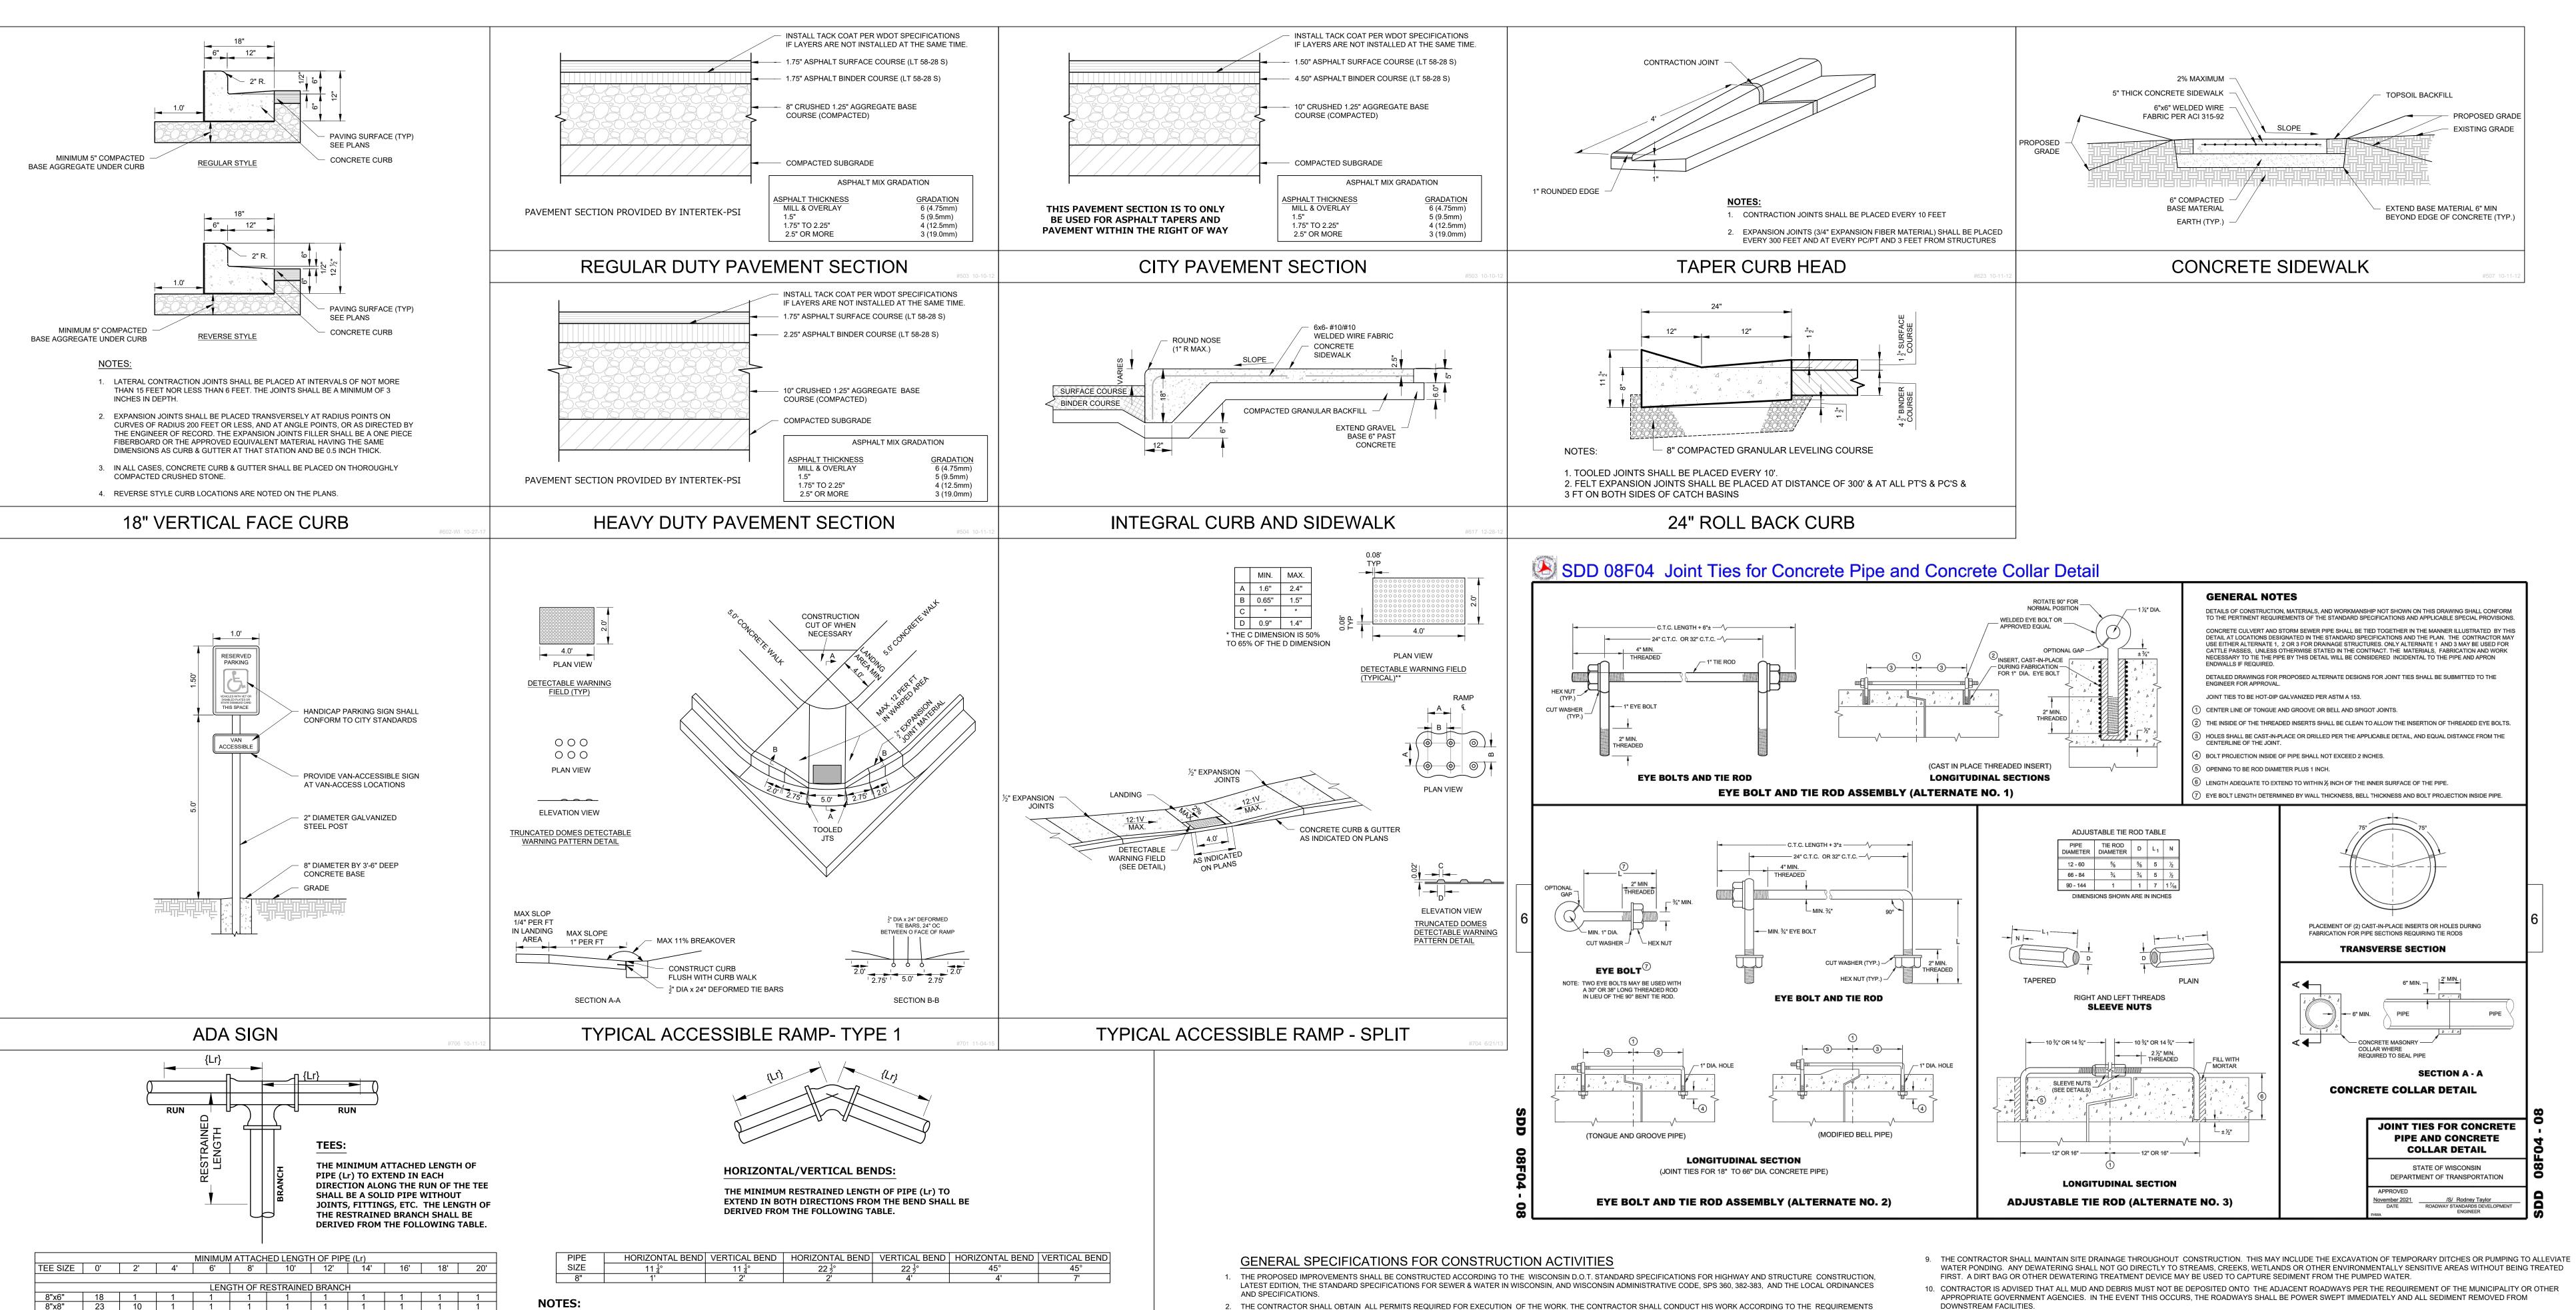

1. THE LENGTHS OF RESTRAINED OR CONTINUOUS PIPE CALLED OUT IN THE FOLLOWING TABLES ARE FOR

C) THE TEST PRESSURE OF THE WATER SYSTEM IS EIGHTY POUNDS PER SQUARE INCH (80 PSI).

2. IF THE FIELD CONDITIONS VARY SIGNIFICANTLY FROM THESE PARAMETERS, THE CONTRACTOR SHALL

IMMEDIATELY ADVISE VILLAGE OF CALEDONIA FIELD INSPECTOR. THE VILLAGE OF CALEDONIA FIELD INSPECTOR

WILL ADVISE THE CONTRACTOR OF THE REQUIRED LENGTH OF RESTRAINED PIPE NECESSARY TO MEET THE

D) THE TRENCH IS TYPE 5, AS PER ANSI/AWWA C150/A21.5, TRENCH CONDITIONS.

A) ALL 6" & 8" PIPE MATERIAL IS PVC.

E) THE DEPTH OF COVER IS SIX FEET (6').

F) THE SAFETY FACTOR SHALL BE 1.5.

WATERMAIN JOINT RESTRAINT LENGTHS

THE MINIMUM LENGTH OF PIPE (Lr) TO BE

FROM THE FOLLOWING TABLE. ALL VALVES

DEAD END | MINIMUM

DIRECTIONS.

SIZE

SHALL BE CONSIDERED DEAD ENDS IN BOTH

RESTRAINED ON A DEAD END SHALL BE DERIVED

RESTRAINED

LENGTH

INSTALLATION OF MECHANICALLY RESTRAINED FITTINGS AND ARE CALCULATED BASED ON THE FOLLOWING

B) THE SOIL TYPE IS "CL" AS DEFINED BY THE UNIFIED SOIL CLASSIFICATIONS, ASTM STANDARD D 2487.

- 2. THE CONTRACTOR SHALL OBTAIN ALL PERMITS REQUIRED FOR EXECUTION OF THE WORK. THE CONTRACTOR SHALL CONDUCT HIS WORK ACCORDING TO THE REQUIREMENTS OF THE PERMITS.
- 3. THE CONTRACTOR SHALL NOTIFY THE OWNER AND THE MUNICIPALITY FORTY- EIGHT (48) HOURS PRIOR TO THE START OF CONSTRUCTION. 4. THE MUNICIPALITY SHALL HAVE THE RIGHT TO INSPECT, APPROVE, AND REJECT THE CONSTRUCTION OF THE PUBLIC PORTIONS OF THE WORK. THE OWNER SHALL HAVE THE RIGHT TO INSPECT, APPROVE, AND REJECT THE CONSTRUCTION OF ALL PRIVATE PORTIONS OF THE WORK.
- INSTALLATION, AND TESTING OF THE WORK ON THIS PROJECT. SITE SAFETY SHALL BE THE SOLE RESPONSIBILITY OF THE CONTRACTOR.

5. THE CONTRACTOR SHALL INDEMNIFY THE OWNER, THE ENGINEER, AND THE MUNICIPALITY, THEIR AGENTS, ETC, FROM ALL LIABILITY INVOLVED WITH THE CONSTRUCTION,

- THE CONTRACTOR IS RESPONSIBLE FOR FIELD VERIFYING ALL UTILITY INFORMATION SHOWN ON THE PLANS PRIOR TO THE START OF CONSTRUCTION. THE CONTRACTOR SHALL CALL DIGGER'S HOTLINE AT 1-800-242-8511 TO NOTIFY THE UTILITIES OF HIS INTENTIONS, AND TO REQUEST FIELD STAKING OF EXISTING UTILITIES. SILT FENCE AND OTHER EROSION CONTROL FACILITIES MUST BE INSTALLED PRIOR TO CONSTRUCTION OR ANY OTHER LAND DISTURBING ACTIVITY. FOLLOW THE SEQUENCE OF CONSTRUCTION ON THE EROSION CONTROL PLAN FOR MORE DETAILS. INSPECTIONS SHALL BE MADE WEEKLY OR AFTER EVERY RAINFALL OF 0.5" OR MORE. REPAIRS SHALL BE MADE IMMEDIATELY. THE CONTRACTOR SHALL BE RESPONSIBLE FOR REMOVING ALL EROSION CONTROL FACILITIES ONCE THE THREAT OF EROSION HAS PASSED WITH THE APPROVAL OF THE GOVERNING AGENCY.
- 9. ANY ADJACENT PROPERTIES OR ROAD RIGHT-OF-WAYS WHICH ARE DAMAGED DURING CONSTRUCTION MUST BE RESTORED BY THE CONTRACTOR. 10. TRASH AND DEBRIS SHALL BE NOT BE ALLOWED TO ACCUMULATE ON THIS SITE AND THE SITE SHALL BE CLEAN UPON COMPLETION OF WORK.
- 11. THE OWNER SHALL HAVE THE RIGHT TO HAVE ALL MATERIALS USED IN CONSTRUCTION TESTED FOR COMPLIANCE WITH THESE SPECIFICATIONS.

# SPECIFICATIONS FOR GRADING & EROSION CONTROL

BE COMPACTED TO 100 PERCENT OF THE STANDARD PROCTOR (ASTM D-398) MAXIMUM DENSITY.

- 1. THE CONTRACTOR SHALL ASSUME SOLE RESPONSIBILITY FOR THE COMPUTATIONS OF ALL GRADING AND FOR ACTUAL LAND BALANCE, INCLUDING UTILITY TRENCH SPOIL. THE CONTRACTOR SHALL IMPORT OR EXPORT MATERIAL AS NECESSARY TO COMPLETE THE PROJECT. CONTRACTOR SHALL NOTIFY OWNER OF THE NEED TO IMPORT OR HAUL OFF SOIL. ON-SITE LOCATIONS SUITABLE FOR BORROW OR FILL MAY BE PRESENT. COORDINATE WITH OWNER.
- 2. THE CONTRACTOR IS RESPONSIBLE FOR VERIFYING SOIL CONDITIONS PRIOR TO COMMENCEMENT OF CONSTRUCTION. A GEOTECHNICAL REPORT MAY BE AVAILABLE FROM THE 3. SITE SHALL BE CLEARED TO THE LIMITS SHOWN ON THE PLANS. REMOVE VEGETATION FROM THE SITE. BURNING IS NOT PERMITTED. PROTECT TREES AND OTHER FEATURES

FROM DAMAGE WITH FENCING. STOCKPILES SHALL NOT BE LOCATED CLOSER THAN 25' TO A DRAINAGE STRUCTURE OR FEATURE AND SHALL BE SURROUNDED WITH SILT FENCE.

- 4. THE GEOTECHNICAL ENGINEER IS RESPONSIBLE FOR VERIFYING COMPACTION AND FILL PLACEMENT IN THE FIELD. THE GEOTECHNICAL ENGINEER MAY SUPERCEDE THESE SPECIFICATIONS IF THERE IS GOOD CAUSE TO DO SO. AN EXPLANATION MUST BE SUBMITTED TO THE ENGINEER IN WITTING BEFORE ANY DEVIATIONS ARE MADE. 5. IF NO GEOTECHNICAL RECOMMENDATION IS AVAILABLE, THEN THE FOLLOWING SPECIFICATIONS SHALL APPLY. ALL FILL SHALL BE CONSIDERED STRUCTURAL FILL AND SHALL BE PLACED IN ACCORDANCE WITH THE FOLLOWING: THE COMPACTED FILL SUBGRADE SHALL CONSIST OF AND SHALL BE UNDERLAIN BY SUITABLE BEARING MATERIALS, FREE OF ALL ORGANIC, FROZEN OR OTHER DELETERIOUS MATERIAL AND INSPECTED AND APPROVED BY THE RESIDENT GEOTECHNICAL ENGINEER. PREPARATION OF THE SUBGRADE. AFTER STRIPPING, SHALL CONSIST OF PROOF-ROLLING TO DETECT UNSTABLE AREAS THAT MIGHT BE UNDERCUT, AND COMPACTING THE SCARIFIED SURFACE TO THE SAME MINIMUM DENSITY INDICATED BELOW. THE COMPACTED FILL MATERIALS SHALL BE FREE OF ANY DELETERIOUS, ORGANIC OR FROZEN MATTER AND SHALL HAVE A MAXIMUM
- LIQUID LIMIT (ASTM-D-423) AND PLASTICITY INDEX (ASTM D-424) IF 30 AND 10 RESPECTFULLY, UNLESS SPECIFICALLY TESTED AND FOUND TO HAVE LOW EXPANSIVE PROPERTIES AND APPROVED BY AN EXPERIENCED SOILS ENGINEER. THE TOP TWELVE (12") INCHES OF COMPACTED FILL SHOULD HAVE A MAXIMUM THREE (3") INCH PARTICLE DIAMETER AND ALL UNDERLYING COMPACTED FILL A MAXIMUM SIX (6") INCH PARTICLE DIAMETER UNLESS SPECIFICALLY APPROVED BY AN EXPERIENCED SOILS ENGINEER. ALL FILL MATERIAL MUST BE TESTED AND APPROVED UNDER THE DIRECTION AND SUPERVISION OF AN EXPERIENCED SOILS ENGINEER PRIOR TO PLACEMENT, IF THE FILL IS TO PROVIDE NON-FROST SUSCEPTIBLE CHARACTERISTICS, IT MUST BE CLASSIFIED AS A CLEAN GW, GP, SW, OR SP PER UNITED SOIL CLASSIFICATION SYSTEM (ASTM D-2487). FOR STRUCTURAL FILL THE DENSITY OF THE STRUCTURAL COMPACTED FILL AND SCARIFIED SUBGRADE AND GRADES SHALL NOT BE LESS THAN 95 PERCENT OF THE MAXIMUM DRY DENSITY AS DETERMINED BY THE STANDARD PROCTOR (ASTM D-698) WITH THE EXCEPTION TO THE TOP 12 INCHES OF PAVEMENT SUBGRADE WHICH SHALL A MINIMUM IN-SITU DENSITY OF 100 PERCENT OF THE MAXIMUM DRY DENSITY, OR 5 PERCENT HIGHER THAN UNDERLYING FILL MATERIALS. THE MOISTURE CONTENT OF COHESIVE SOIL SHALL NOT VARY BY MORE THAN -1 TO +3 PERCENT AND GRANULAR SOIL ±3 PERCENT OF OPTIMUM WHEN PLACED AND COMPACTED OR RECOMPACTED. UNLESS SPECIFICALLY APPROVED BY THE SOILS ENGINEER TAKING INTO CONSIDERATION THE TYPE OF MATERIALS AND COMPACTION EQUIPMENT BEING USED. THE COMPACTION EQUIPMENT SHOULD CONSIST OF SUITABLE MECHANICAL EQUIPMENT SPECIFICALLY DESIGNED FOR SOIL COMPACTION. BULLDOZERS OR SIMILAR TRACKED VEHICLES ARE TYPICALLY NOT SUITABLE FOR COMPACTION. MATERIAL THAT IS TOO WET TO PERMIT PROPER COMPACTION MAY BE SPREAD ON THE FILL AND PERMITTED TO DRY. DISCING, HARROWING OR PULVERIZING MAY BE NECESSARY TO REDUCE THE MOISTURE CONTENT TO A SATISFACTORY VALUE, AFTER WHICH IT SHALL BE COMPACTED. THE FINISHED SUBGRADE AREAS OF THE SITE SHALL
- 6. NO FILL SHALL BE PLACED ON A WET OR SOFT SUBGRADE. THE SUBGRADE SHALL BE PROOF-ROLLED AND INSPECTED BY THE GEOTECHNICAL ENGINEER BEFORE ANY MATERIAL
- 7. SUBGRADE TOLERANCES ARE +/-1" FOR LANDSCAPE AREAS AND +/-½" FOR ALL PAVEMENT AND BUILDING AREAS. 8. TOPSOIL SHALL BE FREE OF DELETERIOUS MATERIALS, ROOTS, OLD VEGETATION, ROCKS OVER 2" DIAMETER AND SHALL NOT BE EXCESSIVELY CLAYEY IN NATURE. NO CLUMPS LARGER THAN 4" ARE ACCEPTABLE. TOPSOIL MAY BE AMENDED AS NEEDED WITH SAND OR COMPOST TO BE LOOSE WHEN SPREAD.

- WATER PONDING. ANY DEWATERING SHALL NOT GO DIRECTLY TO STREAMS, CREEKS, WETLANDS OR OTHER ENVIRONMENTALLY SENSITIVE AREAS WITHOUT BEING TREATED
- SPECIFICATIONS FOR PRIVATE UTILITIES BEFORE PROCEEDING WITH ANY UTILITY CONSTRUCTION, THE CONTRACTOR SHALL EXCAVATE EACH EXISTING LATERAL OR POINT OF CONNECTION AND VERIFY THE LOCATION
- AND ELEVATION OF ALL UTILITIES. IF ANY EXISTING UTILITIES ARE NOT AS SHOWN ON THE DRAWINGS, THE CONTRACTOR SHALL NOTIFY THE ENGINEER IMMEDIATELY FOR 2. ALL CONNECTIONS TO EXISTING PIPES AND MANHOLES SHALL BE CORED CONNECTIONS. CONNECTIONS TO WATERMAIN SHALL BE WET TAPED WITH A STAINLESS STEEP
- 3. PROPOSED SANITARY SEWER AND INTERNALLY CONNECTED STORM SEWER SHOWN ON THIS PLAN SHALL TERMINATE AT A POINT FIVE (5) FEET FROM THE EXTERIOR BUILDING WALL. THE EXACT LOCATION OF ALL DOWN SPOUTS CONNECTIONS SHALL BE PER THE ARCHITECTURAL PLANS.
- 4. CONTRACTOR SHALL NOT SHUT OFF WATER OR PLUG SANITARY SEWER IN MUNICIPAL LINES WITHOUT PRIOR APPROVAL. 5. MATERIALS FOR STORM SEWER SHALL BE AS FOLLOWS: STORM SEWER PIPE 48" OR LESS SHALL BE HIGH DENSITY POLYETHYLENE (HDPE) CORRUGATED PIPE WITH AN INTEGRALLY FORMED SMOOTH WATERWAY SUCH AS ADS N-12. FOR PIPE 10" OR LESS IN DIAMETER, PVC, ASTM D-3034, SDR-26, MAY ALSO BE USED. WHERE SPECIFICALLY REQUIRED, REINFORCED CONCRETE PIPE (RCP), ASTM C-76, CLASS III OR HIGHER, MAY BE USED. TRENCH SECTION SHALL BE CLASS "B" FOR PVC AND HDPE AND CLASS "C" FOR CONCRETE (PER STANDARD SPECIFICATIONS), MANHOLES, INLETS AND CATCH BASINS SHALL BE PRE CAST REINFORCED CONCRETE, ASTM C-478. CASTINGS SHALL BE HEAVY DUTY CAST IRON. AREA DRAINS SHALL BE PER DETAIL ON PLAN OR EQUIVALENT AND SHALL BE A MINIMUM OF 24" IN DIAMETER. CONNECTIONS TO EXISTING PIPES SHALL BE
- MADE WITH INSERTA WYE OR EQUIVALENT. LAST (3) THREE JOINTS SHALL BE RESTRAINED WITH RODS. 6. MATERIALS FOR SANITARY SEWER SHALL BE AS FOLLOWS: SANITARY SEWER SHALL BE PVC, ASTM D-3034, SDR-35 WITH RUBBER GASKETED JOINTS, CONFORMING TO ASTM D-3212. TRENCH SECTIONS SHALL BE CLASS "B" BEDDING (PER STANDARD SPECIFICATIONS). CRUSHED STONE CHIPS SHALL BE USED FOR BEDDING MATERIAL. CONNECTIONS SHALL BE MAD WITH A INSERTA WYE OR EQUIVALENT. A MINIMUM OF 6' OF COVER IS REQUIRED FOR ALL SANITARY SEWER.
- . MATERIALS FOR WATER SERVICES AND PRIVATE HYDRANTS SHALL BE AS FOLLOWS: WATER SERVICES SHALL BE PVC, HDPE, OR DI AS ALLOWED BY MUNICIPAL CODE, PVC SHALL BE AWWA C-900. DI SHALL BE AWWA C151, CLASS 52 (OR AS REQUIRED BY LOCAL CODE). TRENCH SECTIONS SHALL BE CLASS "B" BEDDING (PER STANDARD SPECIFICATIONS). CRUSHED STONE CHIPS SHALL BE USED FOR BEDDING MATERIAL. CONNECTION SHALL BE MADE WITH A WET TAP, CORPORATE STOP AND VALVE BOX PER MUNICIPAL TANDARDS. A MINIMUM OF 6' COVER IS REQUIRED FOR ALL WATERMAIN. VALVES SHALL BE NONRISING STEM, RESILIENT SEATED GATE VALVES COMPLYING WITH AWWA C50 WITH A THREE PIECE CAST IRON VALVE BOX. INSTALL THRUST BLOCKS AT ALL BENDS AND TEES. DISINFECT ALL NEW LINES AND OBTAIN SAFE WATER SAMPLE PRIOR TO USE. 8. EXTREME CAUTION MUST BE FOLLOWED REGARDING THE COMPACTION OF ALL UTILITY TRENCHES. MECHANICALLY COMPACTED GRANULAR BACKFILL IS REQUIRED UNDER &
- 9. TRACER WIRE (NO. 8 SINGLE STRAND COPPER) AND WARNING TAPE SHALL BE INSTALLED ON ALL UTILITIES IN ACCORDANCE WITH THE LOCAL AND STATE CODES. TRACER WIRE SHALL TERMINATE IN A VALVECO TERMINAL BOX AT EACH END.

WITHIN 5 FEET OF ALL PAVEMENT INCLUDING SIDEWALKS. FLOODING OF BACKFILL MATERIAL IS NOT ALLOWED.

WITH BREAKER RUN STONE AND RECOMPACT. REFER TO THE GEOTECHNICAL REPORT FOR ADDITIONAL SPECIFICATIONS.

10. MANDREL TESTING ON SANITARY LINES AND PRESSURE TESTING ON WATERMAIN MAY BE REQUIRED BY THE OWNER OR MUNICIPALITY. 11. UPON COMPLETION OF FINAL PAVING OPERATIONS, THE UTILITY CONTRACTOR SHALL ADJUST ALL MANHOLE AND INLET RIMS AND VALVE BOXES TO FINISHED GRADE.

# SPECIFICATIONS FOR PAVING

- 1. AGGREGATES USED IN THE CRUSHED STONE BASE SHALL CONFORM TO THE GRADATION REQUIREMENTS SECTIONS 301 AND 305 OF THE STATE STANDARD SPECIFICATIONS. THICKNESS SHALL BE PER THE DETAIL ON THE PLANS AND SHALL NOT BE LESS THAN PLAN THICKNESS. BASE SHALL BE 1 1/2" INCH DIAMETER LIMESTONE TRAFFIC BOND AGGREGATE BASE COURSE UNLESS NOTED OTHERWISE. SUBSTITUTION AND/OR RECYCLED MATERIALS MAY BE ALLOWED WITH APPROVAL FROM THE OWNER. 2. SUBGRADE SHALL BE PROOFROLLED AND APPROVED BY A GEOTECHNICAL ENGINEER PRIOR TO PLACEMENT OF STONE BASE. EXCAVATE UNSUITABLE AREAS AND REPLACE
- 3. EXISTING PAVEMENT SHALL BE SAWCUT IN NEAT STRAIGHT LINES TO FULL DEPTH AT ANY POINT WHERE EXISTING PAVEMENT IS REMOVED. CURB AND WALK SHALL BE REMOVED TO THE NEAREST JOINT. REMOVED PAVEMENT SHALL BE REPLACED WITH THE SAME SECTION AS EXISTING. MUNICIPAL STANDARDS MAY REQUIRE ADDITIONAL WORK. 4. ASPHALT FOR PARKING AREAS AND THE PRIVATE ROAD SHALL BE PER THE DETAILS MATERIALS AND PLACEMENT SHALL CONFORM TO THE DOT STANDARD SPECIFICATIONS,

SECTION 450 AND 460. LT 58-28 S IS REQUIRED UNLESS NOTED OTHERWISE. A COMMERCIAL GRADE MIX MAY BE SUBSTITUTED ONLY WITH APPROVAL FROM THE OWNER.

- 5. CONCRETE FOR PARKING AREAS AND PRIVATE ROAD SHALL BE PER THE DETAILS, MATERIALS AND PLACEMENT SHALL CONFORM TO THE DOT STANDARDS SPECIFICATIONS, SECTIONS 415 & 501. GRADE A CONCRETE PAVEMENT SHALL CONFORM TO SECTION 501 OF STATE STANDARD SPECIFICATIONS. CONCRETE CURB AND GUTTER SHALL CONFORM TO SECTIONS 415, 501 & 601 OF THE STATE STANDARD SPECIFICATIONS AND SIDEWALKS SHALL CONFORM TO SECTIONS 415, 501 & 602 OF THE STATE STANDARD
- SPECIFICATIONS, CONSTRUCTION JOINTS SHALL BE SPACED NOT FURTHER THAN 10' FOR PAVEMENT, 10' FOR SIDEWALKS (OR THE WIDTH OF THE WALK), AND 15' FOR CURB. EXPANSION JOINTS SHALL BE SPACED NO FURTHER THAN 50' FOR PAVEMENT, 300' FOR CURB, AND 100' FOR WALKS. CONCRETE SHALL BE FINISHED PER SECTION 415.3.8 WITH A MEDIUM BROOM TEXTURE. A CURING MEMBRANE IN CONFORMANCE WITH SECTION 415.3.12 IS REQUIRED. 6. ALL PAVEMENT MARKINGS SHALL CONFORM TO SECTIONS 646.2 & 646.3 OF THE STATE STANDARD SPECIFICATIONS. ALL PAVEMENTS SHALL BE FOUR (4) INCH WIDE WHITE
- STRIPES UNLESS OTHERWISE NOTED ON PLANS OR DIRECTED BY OWNER. LAYOUT MARKINGS USING GUIDELINES, TEMPLATES AND FORMS. STENCILS AND TEMPLATES SHALL BE PROFESSIONALLY MADE TO INDUSTRY STANDARDS. "FREE HEAD" PAINTING OF ARROWS, SYMBOLS OR WORDING SHALL NOT BE ALLOWED. APPLY STRIPES STRAIGHT AND EVEN. PROTECT ADJACENT CURBS, WALKS FENCES AND OTHER ITEMS FROM RECEIVING PAINT.



PEG PROJECT #: 2145.00

**PINNACLE** ENGINEERING GROUP ENGINEERING I NATURAL RESOURCES I SURVEYING 20725 WATERTOWN ROAD, SUITE 100 BROOKFIELD, WI 53186 (262) 754-8888

Milwaukee, Wisconsin 53202

p 414.431.8101


DOCUMENTS


WATER'S EDGE -

Water's Edge Road Caledonia, WI 53108 Date Issued: 12/12/2023 RINKA project #: 220504

Sheet Title

CONSTRUCTION

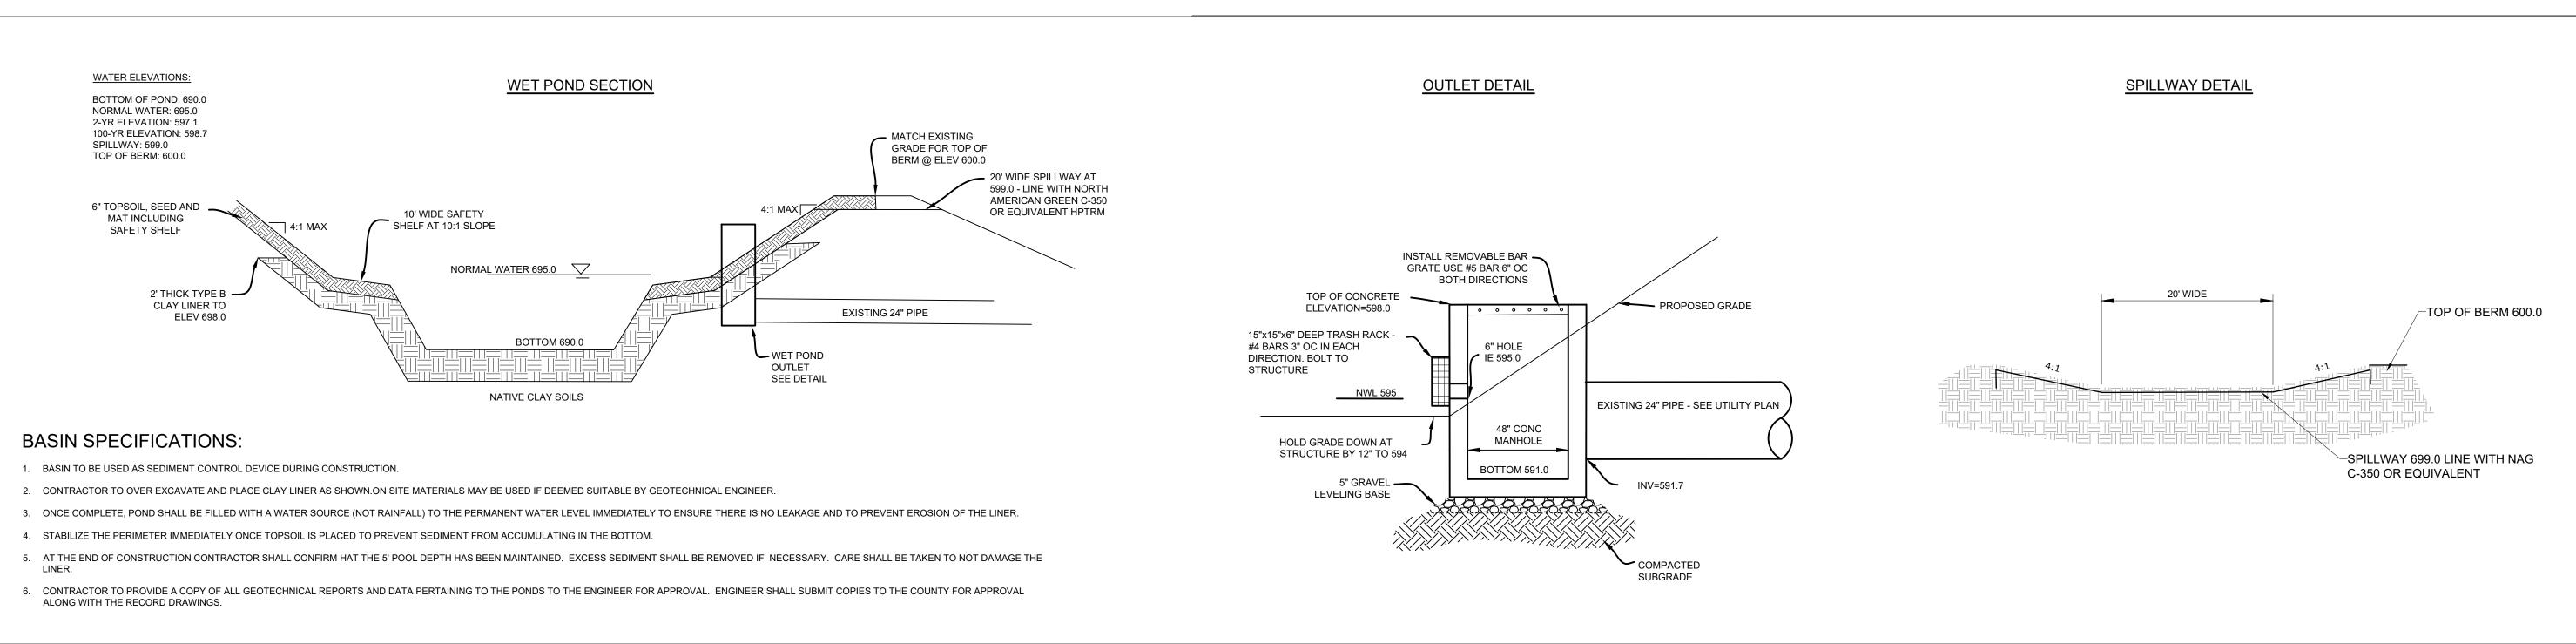

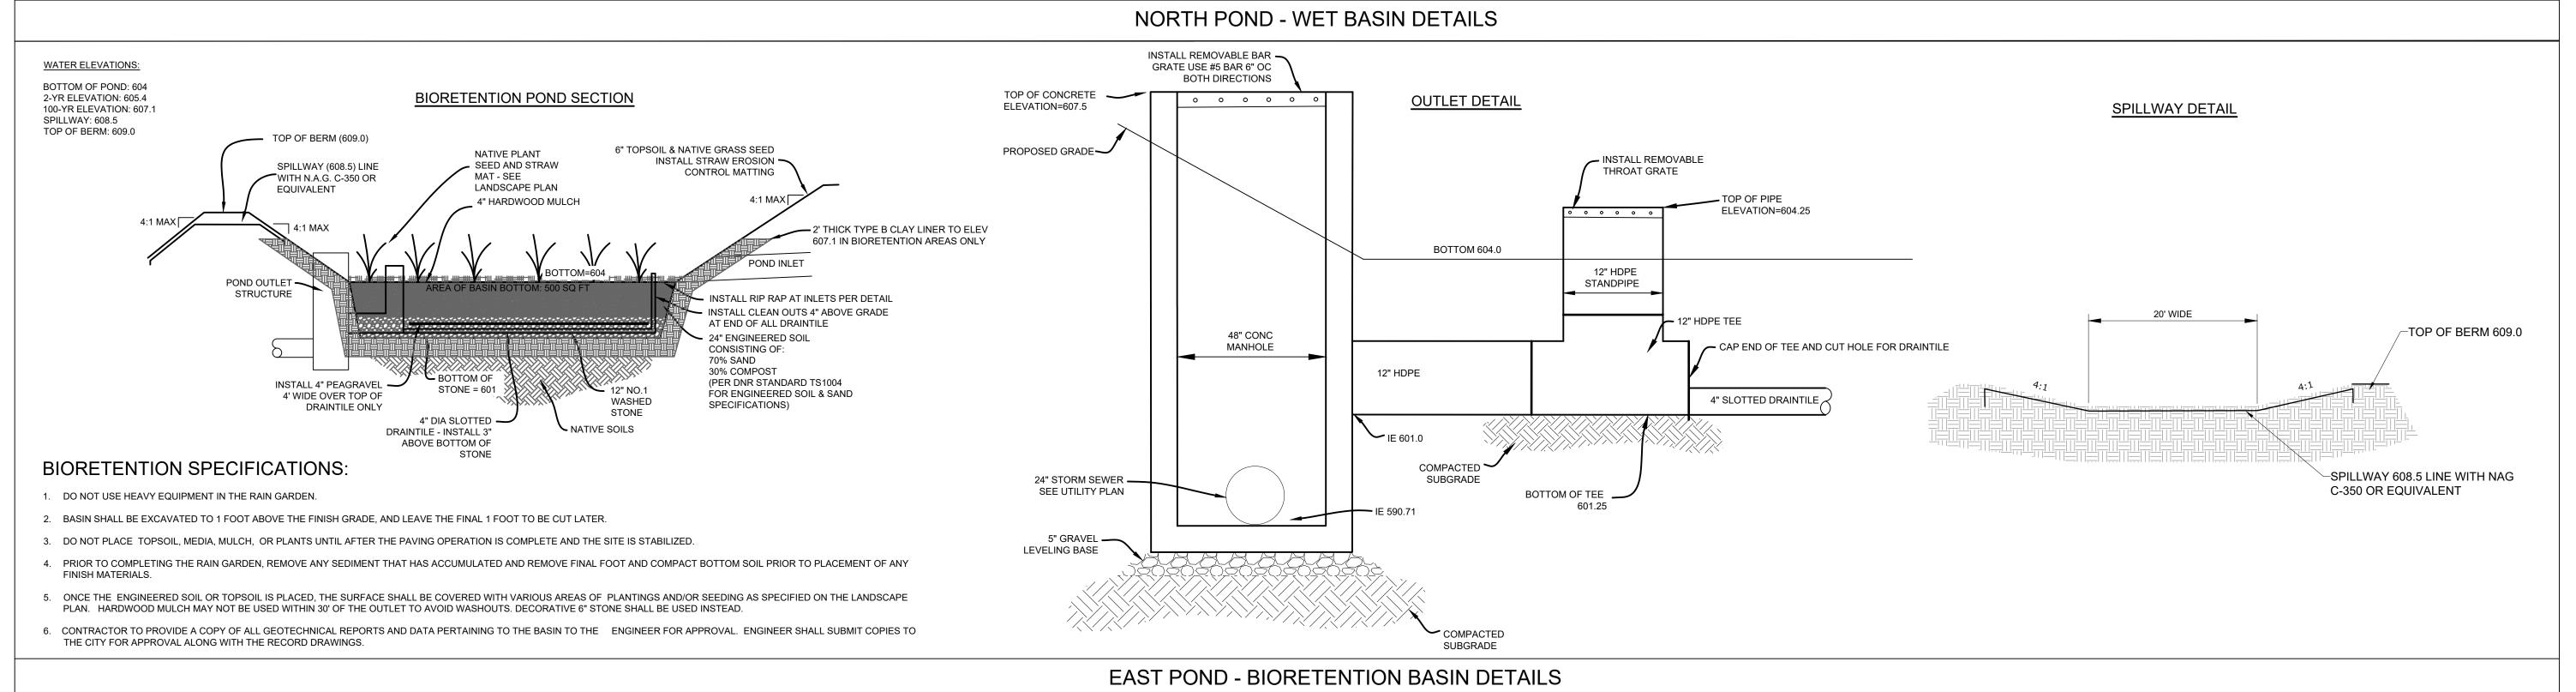

 $\triangle$  Revisions

Milwaukee, Wisconsin 53202

p 414.431.8101

100% CONSTRUCTION DOCUMENTS

WATER'S EDGE -PHASE 1 -TOWNHOMES & CLUBHOUSE

Water's Edge Road Caledonia, WI 53108 Date Issued: 12/12/2023 RINKA project #: 220504

Sheet Title

Sheet #

CONSTRUCTION
DETAILS &
SPECIFICATIONS

C117

PINNACLE ENGINEERING GROUP
ENGINEERING I NATURAL RESOURCES I SURVEYING
20725 WATERTOWN ROAD, SUITE 100
BROOKFIELD, WI 53186
(262) 754-8888
PEG PROJECT #: 2145.00

#### **MEMORANDUM**

authory Bunkelnar

DATE: Thursday, January 4, 2024

**TO:** Caledonia Utility District

FROM: Anthony A. Bunkelman P.E.

**Public Services Director** 

**RE:** Acceptance of Infrastructure – Corona Drive Extension

#### **BACKGROUND INFORMATION**

The Village and the Richard & Diane Ruffo Revocable Trust dated 4/22/2009 entered into a Development Agreement for the Corona Drive Extension. The lot, in order to be buildable requires public improvements such as the subdivision system to be made. The subdivision system includes the Sanitary Sewer Main, Sanitary Sewer lateral, Watermain, Water lateral, and Storm Water Facilities.

The work for the Corona Drive Extension, including the subdivision system, has been completed and has been inspected for compliance with the approved plans and specifications. Asbuilt plans have been received and also reviewed.

It is hereby recommended that the subdivision system of the Corona Drive Extension be accepted by the Utility District.


#### RECOMMENDATION

Move to accept the Subdivision System for the Corona Drive Extension.

LEGEND		
	EXISTING	PROPOSED
SANITARY SEWER MANHOLE	S	•
STORM SEWER MANHOLE	<b>(3)</b>	•
STORM SEWER CATCH BASIN (ROUND CASTING)	<b>(</b>	•
STORM SEWER CATCH BASIN (RECTANGULAR CASTING)		
PRECAST FLARED END SECTION	$\triangleleft$	<b>◄</b>
CONCRETE HEADWALL	(	(
VALVE BOX	×	•
FIRE HYDRANT	ď	<u> </u>
CLEANOUT		•
SANITARY SEWER —		
FORCE MAIN —		
STORM SEWER —		
DRAIN TILE —		
WATER MAIN —	w	w
	vv	
FIRE PROTECTION	F	—— FP ——
ELECTRICAL CABLE —	—— E——	
OVERHEAD WIRES —	—— OHW ———	IOHWI
GAS MAIN —	—— G——	IGI
TELEPHONE LINE —	——Т——	——ITI——
UTILITY CROSSING		
CAUTION EXISTING UTILITIES NEARBY		(CAUTION)
GRANULAR TRENCH BACKFILL		
LIGHTING	$\stackrel{\smile}{\sim}$	•
ELECTRICAL TRANSFORMER OR PEDESTAL	TF	
POWER POLE	-0-	-
POWER POLE WITH LIGHT	$\rightleftharpoons$	<del>`</del>
GUY WIRE	- <b>①</b>	
STREET SIGN	Þ	<b>þ</b>
CONTOUR	749	749
SPOT ELEVATION	×(750.00)	<del>+</del> 750.00
WETLANDS —	WET-	
PRIMARY ENVIRONMENTAL CORRIDOR —	PEC	
FLOODWAY —		
FLOODPLAIN —		
HIGH WATER LEVEL (HWL)	****	
NORMAL WATER LEVEL (NWL) —	,m.	
DIRECTION OF SURFACE FLOW	<b></b>	GRASS PAVEMENT
DITCH OR SWALE —	->>	GRASS PAVEMENT
DIVERSION SWALE —		
OVERFLOW RELIEF ROUTING		
	6" / / 6"	<b>-</b> /
TREE WITH TRUNK SIZE	B-0	<b>B</b> -1
SOIL BORING	<b>──</b> 	T-1
TOPSOIL PROBE	<del>-      </del>	<b>-₽</b> -
FENCE LINE, TEMPORARY SILT —	——— SF———	SF
FENCE LINE, WIRE —	——— SF———	——————————————————————————————————————
FENCE LINE, CHAIN LINK OR IRON —	0	<del></del> o
FENCE LINE, WOOD OR PLASTIC —		
CONCRETE SIDEWALK		
CURB AND GUTTER ==		
DEPRESSED CURB ==		
REVERSE PITCH CURB & GUTTER		<del></del>

	ABBRE	VIA	TIONS
BL BP C & G CB CL D EP FF FG FL FP FR FW FYG HWL INV	BASE LINE BOTTOM OF PIPE LONG CHORD OF CURVE CURB AND GUTTER CATCH BASIN CENTERLINE DEGREE OF CURVE EDGE OF PAVEMENT FINISHED FLOOR FINISHED GRADE FLOW LINE FLOODPLAIN FRAME FLOODWAY FINISHED YARD GRADE HIGH WATER LEVEL INVERT LENGTH OF CURVE	MH NWL PC PT PVI R ROW SAN ST T TB TC TF TP TS TW WM	MANHOLE NORMAL WATER LEVEL POINT OF CURVATURE POINT OF TANGENCY POINT OF VERTICAL INTERSECTION RADIUS RIGHT-OF-WAY SANITARY SEWER STORM SEWER TANGENCY OF CURVE TOP OF BANK TOP OF CURB TOP OF FOUNDATION TOP OF PIPE TOP OF SIDEWALK TOP OF FOUNDATION WALL WATER MAIN INTERSECTION ANGLE

-----

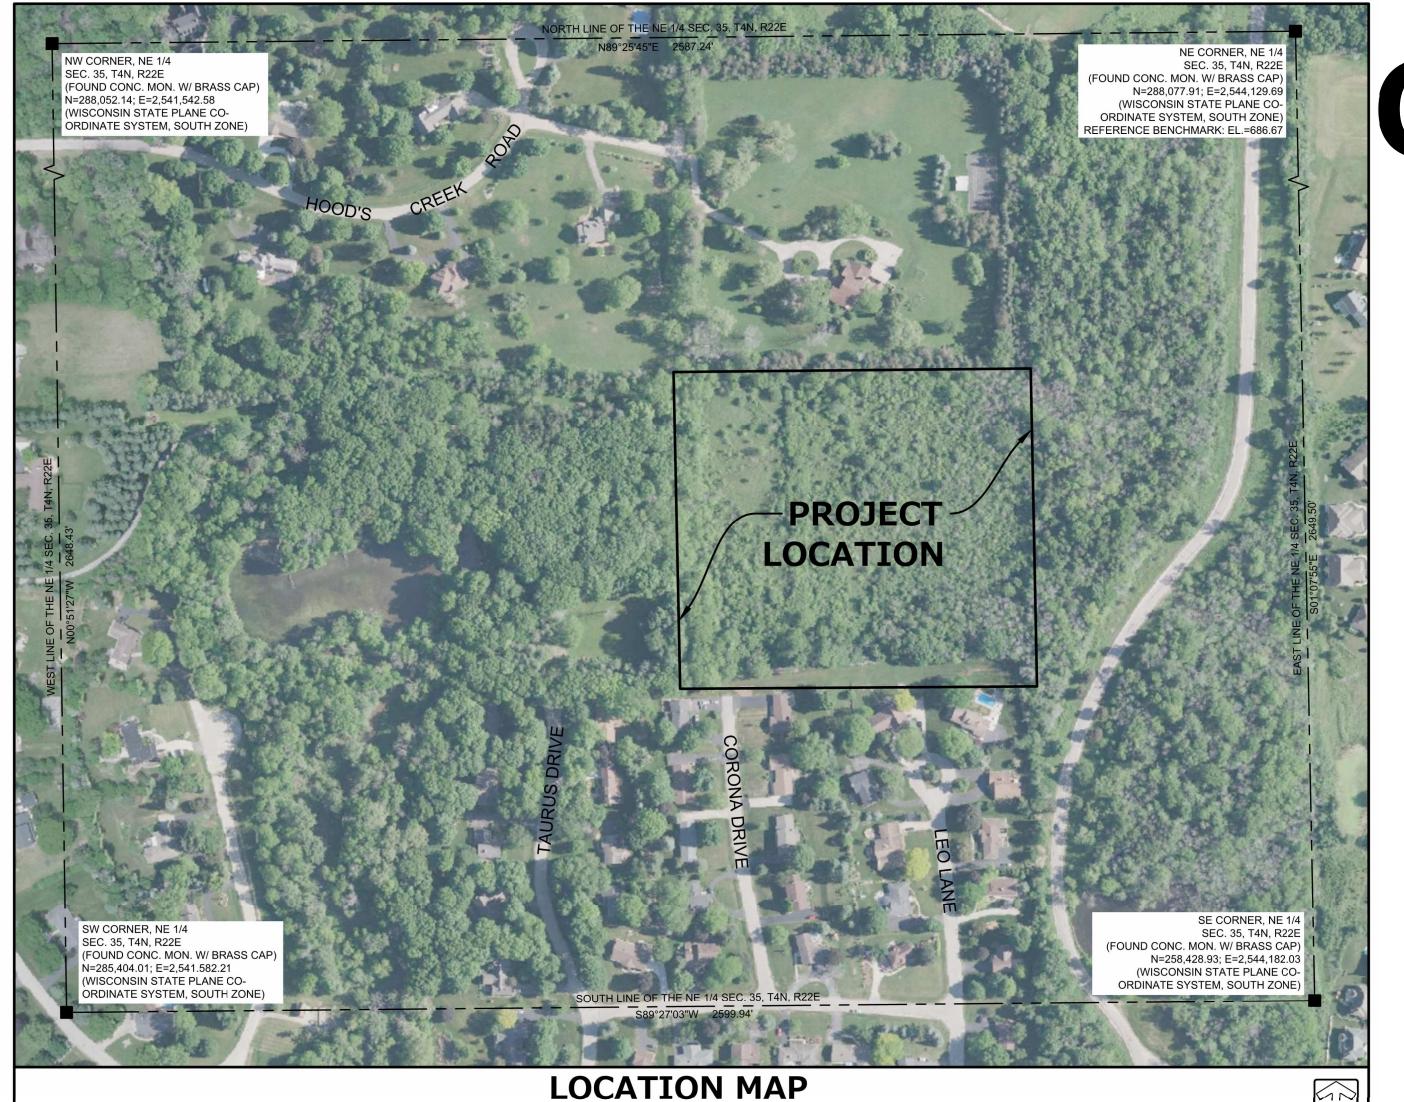

# **ENGINEERING IMPROVEMENT PLANS**

# CORONA DRIVE EXTENSION

# VILLAGE OF CALEDONIA, WI

RICHARD & DIANE RUFFO REVOCABLE TRUST

PLANS PREPARED FOR

**ATTN: RICHARD RUFFO** 9 IRONWOOD COURT **RACINE, WI 53402** PHONE: 262-994-5550

	INDEX OF SHEETS
C-1	COVER SHEET
C-2	PROP. SANITARY SEWER PLAN & PROFILE
C-3	PROP. WATER MAIN PLAN & PROFILE
C-4	PROP. PAVING AND STORM SEWER PLAN & PROFILE
C-5	GRADING & EROSION CONTROL PLAN
C-6 - C-7	CONSTRUCTION DETAILS
1	l de la companya de

# RECORD DRAWINGS

### **GENERAL NOTES**

- THE INTENTION OF THE PLANS AND SPECIFICATIONS IS TO SET FORTH PERFORMANCE AND CONSTRUCTION MATERIAL STANDARDS FOR THE PROPER EXECUTION OF WORK, ALL WORKS CONTAINED WITHIN THE PLANS AND SPECIFICATIONS SHALL BE COMPLETED IN ACCORDANCE WITH ALL REQUIREMENTS FROM LOCAL, STATE, FEDERAL OR OTHER GOVERNING AGENCY'S LAWS, REGULATIONS, JURISDICTIONAL ORDINANCES/CODES/RULES/ETC., AND THE
- 2. THE CONTRACTOR IS RESPONSIBLE TO REVIEW AND UNDERSTAND ALL COMPONENTS OF THE PLANS AND SPECIFICATIONS. INCLUDING FIELD VERIFYING SOIL CONDITIONS. PRIOR TO SUBMISSION OF A BID PROPOSAL.
- THE CONTRACTOR SHALL PROMPTLY REPORT ANY ERRORS OR AMBIGUITIES LEARNED AS PART OF THEIR REVIEW OF PLANS, SPECIFICATIONS, REPORTS AND FIELD INVESTIGATIONS.

SPECIFICATIONS AND PLANS, THE ONE ESTABLISHING THE MOST STRINGENT REQUIREMENTS SHALL BE FOLLOWED.

**SCALE: 1" = 200'** 

- 4. THE CONTRACTOR IS SOLELY RESPONSIBLE FOR THE COMPUTATION OF QUANTITIES AND WORK REQUIRED TO COMPLETE THIS PROJECT. THE CONTRACTOR'S BID SHALL BE BASED ON ITS OWN COMPUTATIONS AND IN NO SUCH INSTANCE RELY ON THE ENGINEER'S ESTIMATE.
- 5. QUESTIONS/CLARIFICATIONS WILL BE INTERPRETED BY ENGINEER/OWNER PRIOR TO THE AWARD OF CONTRACT. ENGINEER/OWNER WILL SUBMIT OFFICIAL RESPONSES IN WRITING. INTERPRETATIONS PRESENTED IN OFFICIAL RESPONSES SHALL BE BINDING ON ALL PARTIES ASSOCIATED WITH THE CONTRACT. IN NO WAY SHALL WORD-OF-MOUTH DIALOG CONSTITUTE AN OFFICIAL RESPONSE.

PRIOR TO START OF WORK, CONTRACTOR SHALL BE COMPLETELY FAMILIAR WITH ALL CONDITIONS OF THE SITE, AND SHALL ACCOUNT FOR CONDITIONS THAT AFFECT, OR MAY AFFECT CONSTRUCTION INCLUDING, BUT NOT LIMITED TO,

LIMITATIONS OF WORK ACCESS, SPACE LIMITATIONS, OVERHEAD OBSTRUCTIONS, TRAFFIC PATTERNS, LOCAL REQUIREMENTS, ADJACENT ACTIVITIES, ETC. FAILURE TO CONSIDER SITE CONDITIONS SHALL NOT BE CAUSE FOR CLAIM OF

- SHOULD ANY DISCREPANCIES OR CONFLICTS IN THE PLANS OR SPECIFICATIONS BE DISCOVERED AFTER THE AWARD OF CONTRACT, ENGINEER SHALL BE NOTIFIED IN WRITING IMMEDIATELY AND CONSTRUCTION OF ITEMS AFFECTED BY

THE DISCREPANCIES/CONFLICTS SHALL NOT COMMENCE, OR CONTINUE, UNTIL A WRITTEN RESPONSE FROM ENGINEER/OWNER IS DISTRIBUTED. IN THE EVENT OF A CONFLICT BETWEEN REFERENCED CODES, STANDARDS,


- THE CONTRACTOR SHALL, AT ITS OWN EXPENSE, OBTAIN ALL NECESSARY PERMITS AND LICENSES TO COMPLETE THE PROJECT. OBTAINING PERMITS, OR DELAYS, IS NOT CAUSE FOR DELAY OF THE CONTRACT OR SCHEDULE. CONTRACTOR SHALL COMPLY WITH ALL PERMIT REQUIREMENTS.
- 10. THE CONTRACTOR SHALL NOTIFY ALL INTERESTED GOVERNING AGENCIES, UTILITY COMPANIES AFFECTED BY THIS CONSTRUCTION PROJECT, AND DIGGER'S HOTLINE IN ADVANCE OF CONSTRUCTION TO COMPLY WITH ALL JURISDICTIONAL ORDINANCES/CODES/RULES/ETC., PERMIT STIPULATIONS, AND OTHER APPLICABLE STANDARDS.
- 11. SAFETY IS THE SOLE RESPONSIBILITY OF THE CONTRACTOR. THE CONTRACTOR SHALL BE RESPONSIBLE TO INITIATE, INSTITUTE, ENFORCE, MAINTAIN, AND SUPERVISE ALL SAFETY PRECAUTIONS AND JOB SITE SAFETY PROGRAMS IN CONNECTION WITH THE WORK
- 12. CONTRACTOR SHALL KEEP THE JOBSITE CLEAN AND ORDERLY AT ALL TIMES. ALL LOCATIONS OF THE SITE SHALL BE KEPT IN A WORKING MANNER SUCH THAT DEBRIS IS REMOVED CONTINUOUSLY AND ALL RESPECTIVE CONTRACTORS
- 13. THE CONTRACTOR SHALL INDEMNIFY THE OWNER, ENGINEER, AND THEIR AGENTS FROM ALL LIABILITY INVOLVED WITH THE CONSTRUCTION, INSTALLATION, AND TESTING OF THE WORK ON THIS PROJECT.

# APPLICANT/ DEVELOPER

RICHARD & DIANE RUFFO REVOCABLE TRUST ATTN: RICHARD RUFFO 9 IRONWOOD COURT RACINE, WI. 53402 (262) 994-5550

### **CIVIL ENGINEERING CONTACTS**

PINNACLE ENGINEERING GROUP ATTN: ANTHONY S. ZANON, P.E. 20725 WATERTOWN ROAD, SUITE 100 BROOKFIELD, WI 53186 (262) 754-8888

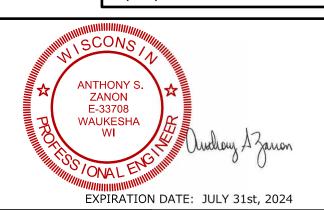



www.DiggersHotline.com

PINNACLE ENGINEERING GROUP, LLC ENGINEER'S LIMITATION

PINNACLE ENGINEERING GROUP, LLC AND THEIR CONSULTANTS DO NOT WARRANT OR GUARANTEE THE ACCURACY AND COMPLETENESS OF THE DELIVERABLES HEREIN BEYOND A REASONABLE DILIGENCE. IF ANY MISTAKES, OMISSIONS, OR DISCREPANCIES ARE FOUND TO EXIST WITHIN THE DELIVERABLES. THE ENGINEER SHALL BE PROMPTLY NOTIFIED PRIOR TO BID SO THAT HE MAY HAVE THE OPPORTUNITY TO TAKE WHATEVER STEPS NECESSARY TO RESOLVE THEM. FAILURE TO PROMPTLY NOTIFY THE ENGINEER OF SUCH CONDITIONS SHAL ABSOLVE THE ENGINEER FROM ANY RESPONSIBILITY FOR THE CONSEQUENCES OF SUCH FAILURE. ACTIONS TAKEN WITHOUT THE KNOWLEDGE AND CONSENT TO THE ENGINEER, OR IN CONTRADICTION TO THE ENGINEER'S DELIVERABLES OR RECOMMENDATIONS, SHALL BECOME THE RESPONSIBILITY NOT OF THE ENGINEER BUT OF THE PARTIES RESPONSIBLE FOR TAKING SUCH ACTION.



EASEMENT LINE

PLAN I DESIGN I DELIVER www.pinnacle-engr.com

5850 W BLUFMOUND ROAD


**CORONA DRIVE EXTENSION** VILLAGE OF CALEDONIA, RACINE CO.

**COVER SHEET** 

	REVISIONS	93.00	ASZ	)7-23	
1 VILLAGE COMMENTS	03-30-23	785		05-0	Ī

**INSTALLED BY WANASEK AUGUST 2023 - SEPTEMBER 2023** 

> **RECORD DRAWINGS BY:** FOTH INFRASTRUCTURE

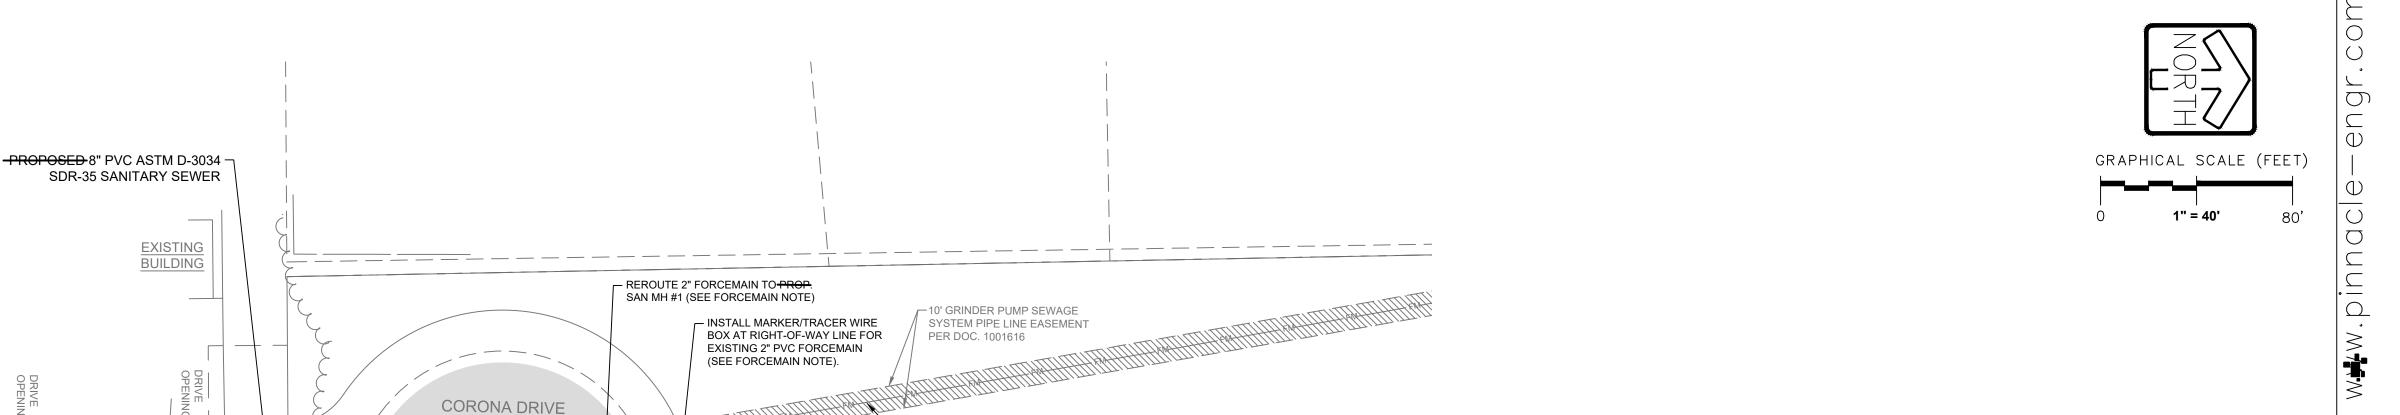

APPROXIMATE LOCATION OF AN EXISTING 2" PVC SANITARY FORCEMAIN SERVING TWO SINGLE FAMILY HOMES (6635 E HOODS CREEK LANE (BENBEN) AND 6427 HOODS CREEK ROAD (PLATT & SNYDERMAN) LOCATED AT THE NORTH AND NORTHWEST CORNER OF THE SUBJECT PROPERTY. EXACT LOCATION AND DEPTH OF

FORCEMAIN IS UNKNOWN. UTILITY CONTRACTOR TO START IN THE

EXISTING MANHOLE IN CORONA DRIVE AND POTHOLE THE MAIN TO A

POINT APPROXIMATELY 550' NORTH OF THE MANHOLE WHICH WOULD

BE OUTSIDE OF THE WORK AREA OF THIS PROJECT. CONTRACTOR TO COORDINATE WITH TWO HOMEOWNERS TO MAINTAIN SERVICE

AND TO RECONNECT THE FORCEMAIN TO PROP. MH #1.

-20' WIDE STORM SEWER

<del>PROP</del> SAN MH #1

RIM<del>=696.90</del> 696.87

D=<del>10.00'</del> 10.1' INV<del>=686.90-</del>(8" S) **686.74** INV<del>=687.50</del> (2" N) **686.81** 

COVER EL=697.2-697.66

INV=688.69- 688.60

STA++85.59 (12.39' R)

75 LF


PROPOSED CLEANOUT AT R-O-W LINE

PROPOSED 4" SANITARY LATERAL

I<del>OPOSED 75 L.F.</del>-4" SANITARY LATERAL @<del>-2.08%</del> 3.20%

EASEMENT GRANTED TO

THE VILLAGE OF CALEDONIA

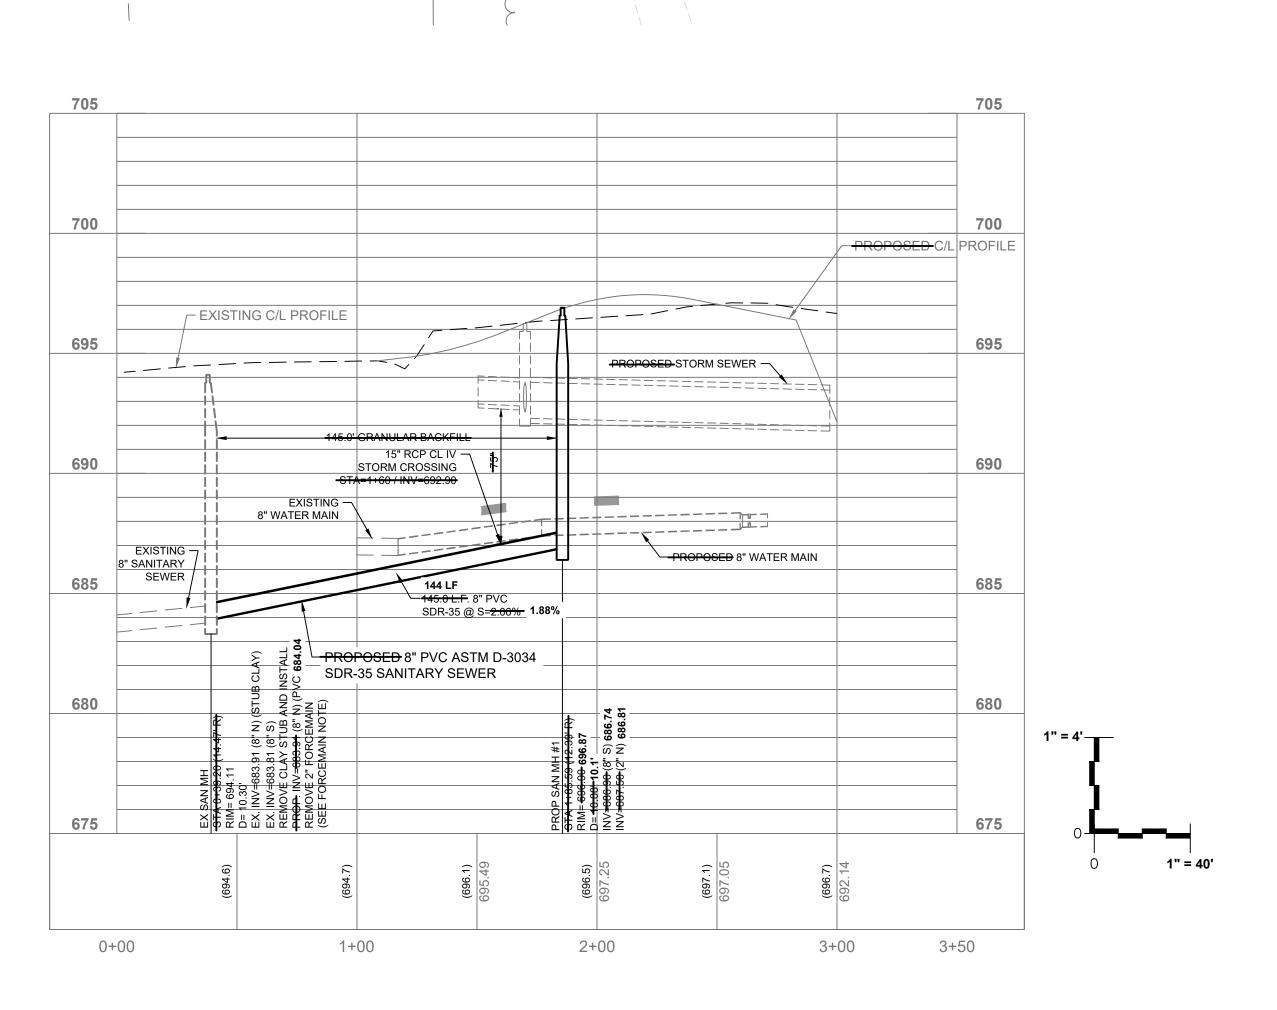

SDR-35 @ S<del>-2.06%</del>

EX. INV=683.81 (8" S)

REMOVE 2" FORCEMAIN

(SEE FORCEMAIN NOTE)

EX. INV=683.91 (8" N) (STUB CLAY)

REMOVE CLAY STUB AND INSTALL

<del>PROP.</del> INV<del>=683.91</del> (8" N) (PVC) **684.04** 

BUILDING

EX SAN MH RIM=694.11 D=10.30'

NOTE:

SEE ADDITIONAL NOTES AND DETAILS ON SHEETS 6 AND 7.

NOTE: The location and size of the underground structures and utilities shown hereon have been located to CALL DIGGERS HOTLINE a reasonable degree of accuracy, but the Engineer and/or Surveyor does not guarantee their exact location or the location of others not shown. Contact Diggers Hotline, Inc., Etc.

1-800-242-8511 TOLL FREE WIS STATUTE 182.0175(1974)
REQUIRES MIN. 3 VORK DAYS
NOTICE BEFORE YOU EXCAVATE

DELIVER www.pinnacle-engr.com PLAN I DESIGN I PINNACLE ENGINEERING GROU


CORONA DRIVE EXTENSION VILLAGE OF CALEDONIA, RACINE CO.


PROP. SANITARY SEWER PLAN & PROFILE


REVISIONS 3 TOPSOIL PILE LOCATION 07-20-23

**INSTALLED BY WANASEK AUGUST 2023 - SEPTEMBER 2023** 

> **RECORD DRAWINGS BY:** FOTH INFRASTRUCTURE

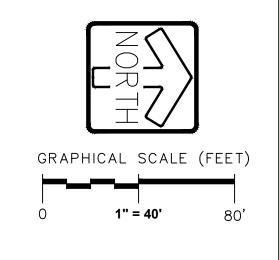

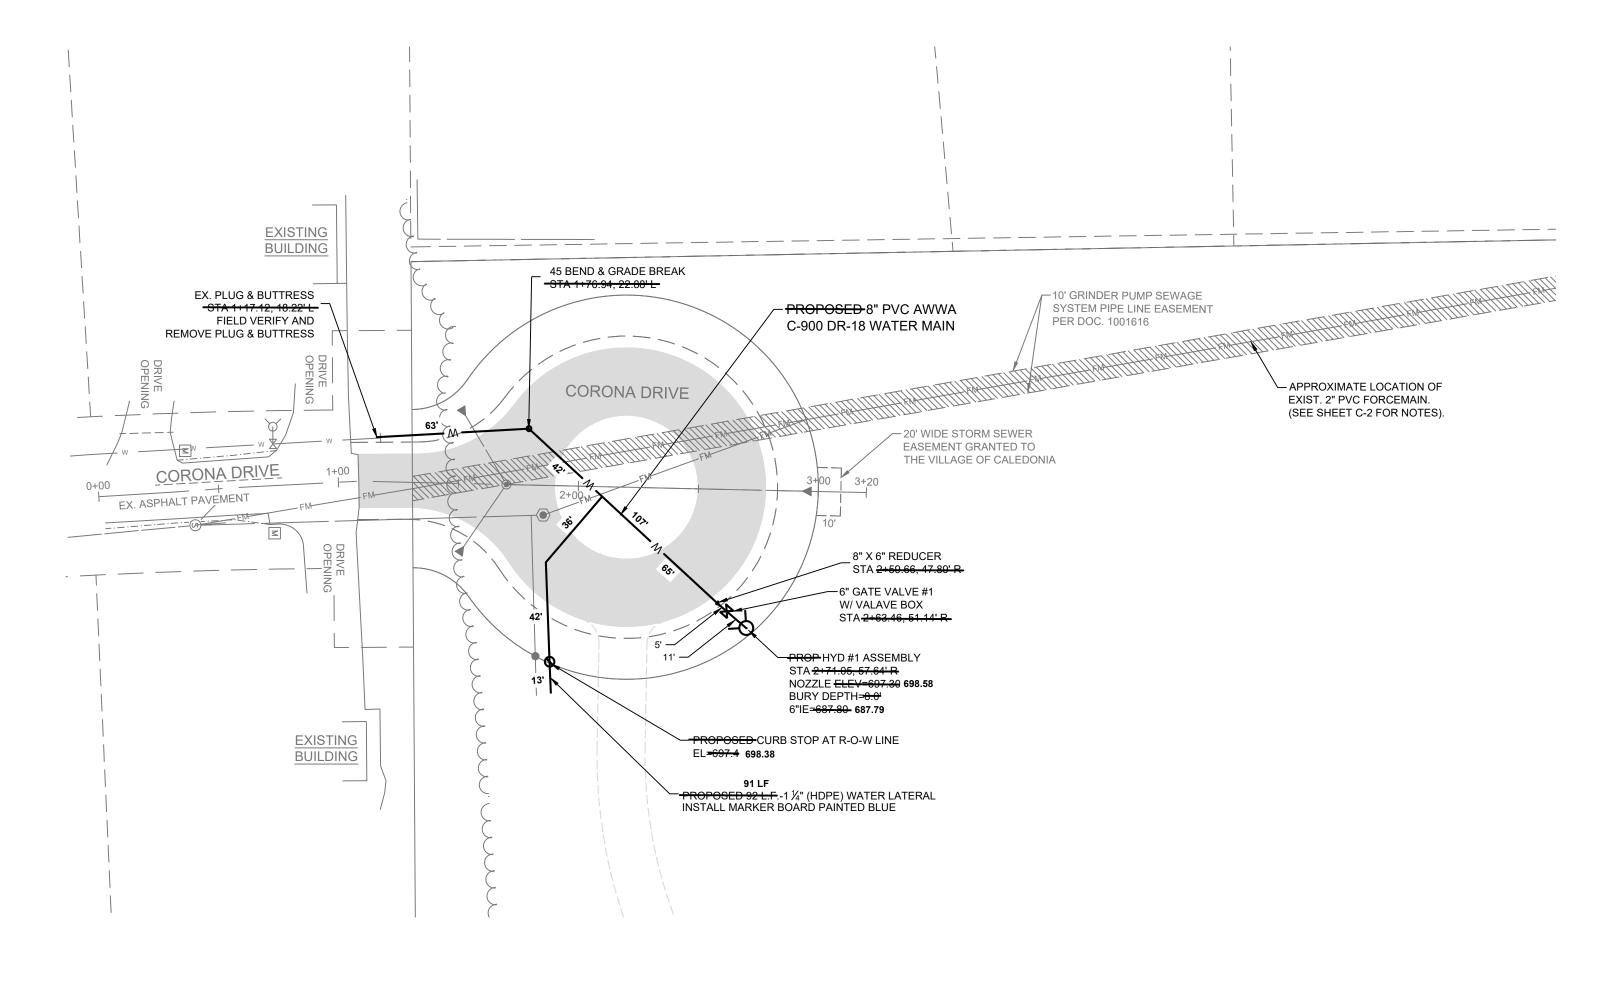

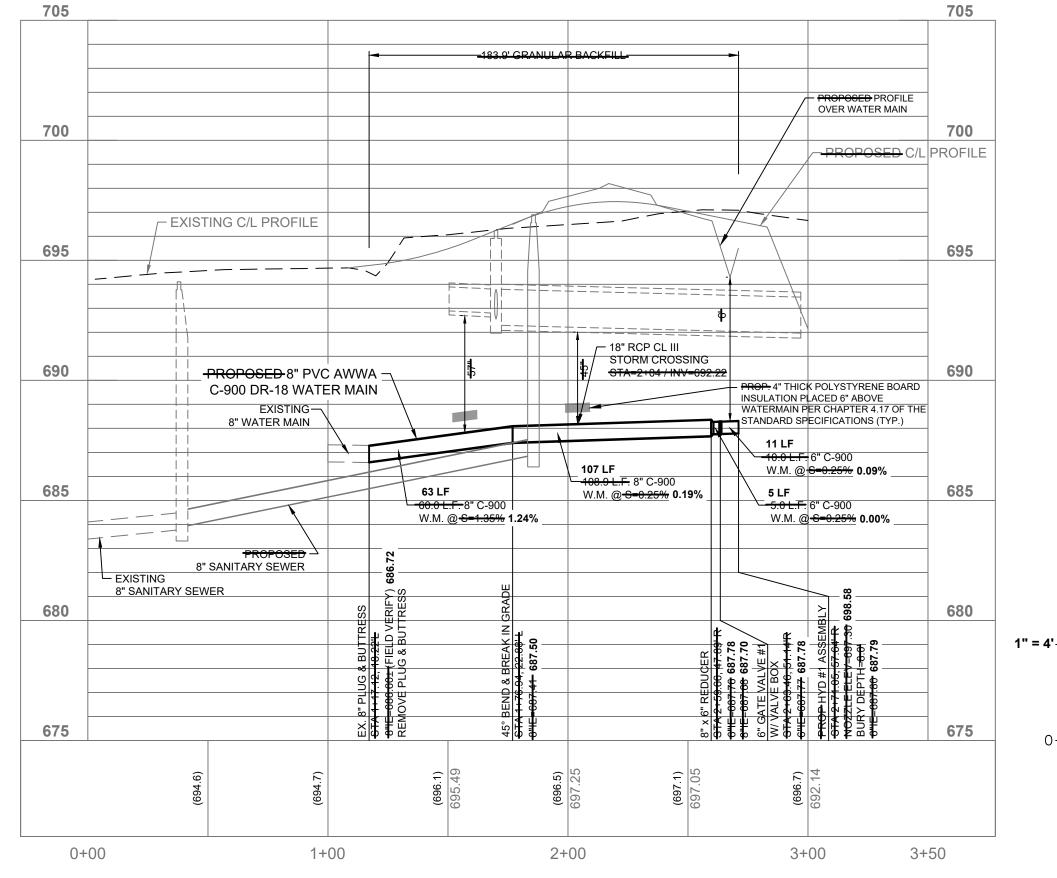

NOTE:

SEE ADDITIONAL NOTES AND DETAILS ON SHEETS 6 AND 7.

1-800-242-8511 TOLL FREE

NOTE: The location and size of the underground structures and utilities shown hereon have been located to CALL DIGGERS HOTLINE a reasonable degree of accuracy, but the Engineer and/or Surveyor does not guarantee their exact location or the location of others not shown. Contact Diggers Hotline, Inc., Etc.

WIS STATUTE 182.0175(1974) REQUIRES MIN. 3 WORK DAYS NOTICE BEFORE YOU EXCAVATE MILW. AREA 259-1181

DELIVER www.pinnacle-engr.com PLAN I DESIGN I PINNACLE ENGINEERING GROUP

CORONA DRIVE EXTENSION VILLAGE OF CALEDONIA, RACINE CO.

PROP. WATER MAIN PLAN & PROFILE

REVISIONS 3 TOPSOIL PILE LOCATION 07-20-23

ONSTRUCTION



NOTE:

SEE ADDITIONAL NOTES AND DETAILS ON SHEETS 6 AND 7.

PVI STA = <del>1+40</del> PVI STA = 2+10 <del>PROP.</del> FLANGE PVI ELEV = 697.85 ELEV = 697.00 HP \$TA = <del>2+20.00</del> HP ELEV = <del>697.45</del> LP STA = 1+20.00 LP ELEV = <del>694.82</del> 700 EX. EOP (MATCH)

ELEV = <del>694.69</del>

STA = <del>1+08.5</del> ELEV = 696.39 STA = 2+83.0 EXISTING C/L PROFILE CENTER C-D-S 124 LF 127.0 L.F. 18" RCP 690 CL. III @ S=<del>0.26%</del> 0.17% ROPOSED 8" WATER MAIN 8" SANITARY SEWER 680 675 675 2+00 3+00 3+50

PROP INLET #1
W/ 12" RCP END SECTION

CORONA DRIVE

<del>35.0 L.F</del>. 15" RCP CL. IV @ S=<del>2.14%</del>

(GRANULAR BACKFILL)

Missing or invalid reference File: , DETAILS \ caledonia rural local road cross section participais (unergraupo participais (unergr Sheet: 1

> NOTE: The location and size of the underground structures and utilities shown hereon have been located to CALL DIGGERS HOTLINE a reasonable degree of accuracy, but the Engineer and/or Surveyor location or the location of others Contact Diggers Hotline, Inc., Etc.

1-800-242-8511 TOLL FREE

DELIVER www.pinnacle-engr.com PLAN | DESIGN |

RIGHT-OF-WAY PLATTED ON-THE ALDEBARAN SUBDIVISION PLAT THAT WAS NOTED ON THE PLAT AS "TEMPORARY

EASEMENT FOR PUBLIC

DRIVE IS EXTENDED.

STREET PURPOSES" SHALL

BE VACATED ONCE CORONA

PROP INLET #2

W/ 15" RCP END SECTION

\_\_ 693.34

BUILDING

STA. <del>1+50.82 (29.28'R)</del>

INV=693.30 (15" NW)

CORONA DRIVE EXTENSION VILLAGE OF CALEDONIA, RACINE CO.

─10' GRINDER PUMP SEWAGE SYSTEM PIPE LINE EASEMENT

APPROXIMATE LOCATION OF

EXIST. 2" PVC FORCEMAIN. (SEE SHEET C-2 FOR NOTES).

PER DOC. 1001616

-20' WIDE STORM SEWER EASEMENT GRANTED TO THE VILLAGE OF CALEDONIA

-30" INVERTED MOUNTABLE

W/ 18" RCP END SECTION STA.<del>2+97.00 (0.00')</del>

-5' GRAVEL SHOULDER

**CURB & GUTTER** 

PROP. PAVING AND STORM SEWER PLAN & PROFILE

REVISIONS

#### **MEMORANDUM**

authory Bunkelnar

DATE: Thursday, January 4, 2024

TO: Caledonia Utility District

FROM: Anthony A. Bunkelman P.E.

**Public Services Director** 

**RE:** Authorization of Signatures – Watermain & Sewer Assessment

Agreement - 13108 4 Mile Road - Rebecca Keeku

#### **BACKGROUND INFORMATION**

The Village Board has requested that the Settlement Agreement that was executed with the property owners in the lawsuit be offered to the remaining property owners along 4 Mile Road. The property owners were sent letters requiring a response to be given if they wanted to accept the same terms as the Settlement Agreement. The property owner listed above is one of the owners that have requested the Settlement Agreement terms.

The Village Attorney has drafted the original Agreements for the owners and at the Village Board meeting outside Village Council directed the Village Board to have the Agreements rewritten.

Attached is the Updated Watermain and Sewer Assessment Agreement.

It is recommended that the signature of the Utility District President is authorized to execute the Agreement.

#### RECOMMENDATION

Move to authorize the President of the Caledonia Utility District to execute the Watermain & Sewer Assessment Agreement with Rebecca Keeku of 13108 4 Mile Road.

#### WATERMAIN AND SEWER ASSESSMENT AGREEMENT

The parties to this Settlement Agreement are Rebecca Keeku ("OWNER" as used herein) and the Village of Caledonia ("VILLAGE" as used herein), which may collectively be referred to as "parties" herein. The parties have agreed to settle and resolve all issues on the provisions listed below.

- 1. The VILLAGE shall **vacate and remove** the special assessments against the property of the OWNER as described in **Exhibit A** ("Property"), annexed hereto and incorporated by reference, for both water and sewer, in the respective amounts referenced in **Exhibit A**.
- 2. OWNER shall not be required to connect the Property to either the sewer or water systems of the VILLAGE, unless:
  - a. The Property, upon which a Building is located, is rezoned or a conditional use permit is granted;
  - b. The Property, upon which a Building on the property is located, is divided pursuant to Title 14 of the Code of Ordinances for the Village of Caledonia;
  - c. A well serving the existing Building or the Property fails (a pump failure is not considered a well failure) or must be abandoned; or
  - d. The private onsite wastewater treatment system serving the Property needs to be replaced, or if a change in use requires modification or abandonment, or if the sand system fails.
- 3. OWNER may not connect the Property to either the sewer and water systems of the VILLAGE, except upon compliance with the following:
  - a. Connection of the OWNER'S Property to the water system of the VILLAGE, may be made in 2023 or any year thereafter. Should OWNER seek to make such a connection in 2023 and before 2041, payment shall be made pursuant to Resolution 2021-56, Amended Special Assessment Report pages 10-11, paragraph 14, in addition to any applicable impact or connection fees, which is attached hereto as **Exhibit B**.
  - b. Connection of the OWNER'S Property to the sewer system of the VILLAGE, may be made in 2023 or any year thereafter. Should OWNER seek to make such a connection in 2023 and before 2041, payment shall be made pursuant to Resolution 2021-56, Amended Special Assessment Report pages 27-28, paragraph 14, in addition to any applicable connection fees, which is attached hereto as **Exhibit C**.
  - c. Connection of the OWNER'S Property to either the water or sewer systems in 2041 or thereafter will require payment in full of the amounts set forth above.

- d. The provisions of this Agreement are covenants that run with the land and shall be binding upon and inure to the benefit of the parties to this Agreement and their respective heirs, successors and assigns.
- 4. This Agreement may be executed in one or multiple counterparts, each constituting an original, but all of which together shall constitute the complete Settlement Agreement.

This Agreement shall become effective when signed by the OWNER and by authorized representative(s) of the VILLAGE. It may be recorded in the office of the Register of Deeds for Racine County.

[Signature Pages to Follow]

Dated: 11-12-23	Rebecca Keeku
	Village of Caledonia
Dated: 12 · 12 · 25	Thomas Weatherston Village President
Dated: 12-12-23	Wayne Knueger
	By: Joslyn Hoeffert Village Clerk, Deputy
	Caledonia Sewer and Water Utility Distric
Dated:	D II 1 Chancer
	By: Howard Stacey President

#### **EXHIBIT A**

- 1. OWNER property located at 13108 4 Mile Road, Franksville, WI 53126; Tax No: 51-104-04-22-19-069-000
- 2. Total assessment \$16,919.30 (\$9,945.74 for sewer and \$6,973.56 for water)

#### **MEMORANDUM**

DATE: Thursday, January 4, 2024

**TO:** Caledonia Utility District

FROM: Anthony A. Bunkelman P.E.

**Public Services Director** 

**RE:** Authorization of Signatures – Watermain & Sewer Assessment

Agreement - 13510 4 Mile Road - William & Judith Hurtienne

authory Bunkelnar

#### BACKGROUND INFORMATION

The Village Board has requested that the Settlement Agreement that was executed with the property owners in the lawsuit be offered to the remaining property owners along 4 Mile Road. The property owners were sent letters requiring a response to be given if they wanted to accept the same terms as the Settlement Agreement. The property owner listed above is one of the owners that have requested the Settlement Agreement terms.

The Village Attorney has drafted the original Agreements for the owners and at the Village Board meeting outside Village Council directed the Village Board to have the Agreements rewritten.

Attached is the Updated Watermain and Sewer Assessment Agreement.

It is recommended that the signature of the Utility District President is authorized to execute the Agreement.

#### RECOMMENDATION

Move to authorize the President of the Caledonia Utility District to execute the Watermain & Sewer Assessment Agreement with William & Judith Hurtienne of 13510 4 Mile Road.

### WATERMAIN AND SEWER ASSESSMENT AGREEMENT

The parties to this Settlement Agreement are William & Judith Hurtienne ("OWNER" as used herein) and the Village of Caledonia ("VILLAGE" as used herein), which may collectively be referred to as "parties" herein. The parties have agreed to settle and resolve all issues on the provisions listed below.

- 1. The VILLAGE shall **vacate and remove** the special assessments against the property of the OWNER as described in **Exhibit A** ("Property"), annexed hereto and incorporated by reference, for both water and sewer, in the respective amounts referenced in **Exhibit A**.
- 2. OWNER shall not be required to connect the Property to either the sewer or water systems of the VILLAGE unless:
  - a. The Property, upon which the Building is located, is rezoned or a conditional use permit is granted;
  - b. The Property, upon which a Building is located, is divided pursuant to Title 14 of the Code of Ordinances for the Village of Caledonia;
  - c. A well serving the existing Building on the Property fails (a pump failure is not considered a well failure) or must be abandoned; or
  - d. The private onsite wastewater treatment system serving the Property needs to be replaced or if a change in use requires modification or abandonment, or if the sand system fails.
- 3. OWNER may not connect the Property to either the sewer and water systems of the VILLAGE, except upon compliance with the following:
  - a. Connection of the OWNER'S Property to the water system of the VILLAGE, may be made in 2023 or any year thereafter. Should OWNER seek to make such a connection in 2023 and before 2041, payment shall be made pursuant to Resolution 2021-56, Amended Special Assessment Report pages 10-11, paragraph 14, in addition to any applicable impact or connection fees, which is attached hereto as **Exhibit B**.
  - b. Connection of the OWNER'S Property to the sewer system of the VILLAGE, may be made in 2023 or any year thereafter. Should OWNER seek to make such a connection in 2023 and before 2041, payment shall be made pursuant to Resolution 2021-56, Amended Special Assessment Report pages 27-28, paragraph 14, in addition to any applicable connection fees, which is attached hereto as **Exhibit C**.
  - c. Connection of OWNER'S Property to either the water or sewer systems in 2041 or thereafter will require payment in full of the amounts set forth above.

- d. The provisions of this Agreement are covenants that run with the land and shall be binding upon and inure to the benefit of the parties to this Agreement and their respective heirs, successors and assigns.
- 4. This Agreement may be executed in one or multiple counterparts, each constituting an original, but all of which together shall constitute the complete Settlement Agreement.

This Agreement shall become effective when signed by the OWNER and by authorized representative(s) of the VILLAGE. It may be recorded in the office of the Register of Deeds for Racine County.

[Signature Pages to Follow]

Dated: Dec. 11, 2023	William Hurtienne William Hurtienne
Dated: Dec. 11, 2023	Judith A. Hartienne
	Village of Caledonia
Dated: 12-12-25	Thomas Weatherston Village President
Dated: 12-12-23	By: Joslyn Hoeffert Village Clerk, Deputy
	Caledonia Sewer and Water Utility District
Dated:	
	By: Howard Stacey President

#### **EXHIBIT A**

- 1. OWNER property located at 13510 4 Mile Road, Franksville, WI 53126; Tax No: 51-104-04-22-19-064-000
- 2. Total assessment \$16,919.30 (\$9,945.74 for sewer and \$6,973.56 for water).

#### **MEMORANDUM**

authory Bunkelnar

DATE: Thursday, January 4, 2024

**TO:** Caledonia Utility District

FROM: Anthony A. Bunkelman P.E.

**Public Services Director** 

**RE:** Authorization of Signatures – Watermain & Sewer Assessment

**Agreement – 13010 4 Mile Road – Darlene Daines** 

#### BACKGROUND INFORMATION

The Village Board has requested that the Settlement Agreement that was executed with the property owners in the lawsuit be offered to the remaining property owners along 4 Mile Road. The property owners were sent letters requiring a response to be given if they wanted to accept the same terms as the Settlement Agreement. The property owner listed above is one of the owners that have requested the Settlement Agreement terms.

The Village Attorney has drafted the original Agreements for the owners and at the Village Board meeting outside Village Council directed the Village Board to have the Agreements rewritten.

Attached is the Updated Watermain and Sewer Assessment Agreement.

It is recommended that the signature of the Utility District President is authorized to execute the Agreement.

#### RECOMMENDATION

Move to authorize the President of the Caledonia Utility District to execute the Watermain & Sewer Assessment Agreement with Darlene Daines of 13010 4 Mile Road.

#### WATERMAIN AND SEWER ASSESSMENT AGREEMENT

The parties to this Settlement Agreement are Darlene Daines ("OWNER" as used herein) and the Village of Caledonia ("VILLAGE" as used herein), which may collectively referred to as "parties" herein. The parties have agreed to settle and resolve all issues on the provisions listed below.

- 1. The VILLAGE shall **vacate and remove** the special assessments against the property of the OWNER as described in **Exhibit A** ("Property"), annexed hereto and incorporated by reference, for both water and sewer, in the respective amounts referenced in **Exhibit A**.
- 2. OWNER shall not be required to connect the Property to either the sewer or water systems of the VILLAGE unless:
  - a. The Property, upon which a Building is located, is rezoned or a conditional use permit is granted;
  - b. The Property, upon which a Building on the Property is located, is divided pursuant to Title 14 of the Code of Ordinances for the Village of Caledonia;
  - c. A well serving the existing Building or the Property fails (a pump failure is not considered a well failure) or must be abandoned; or
  - d. The private onsite wastewater treatment system serving the Property needs to be replaced or if a change in use requires modification or abandonment, or if the sand system fails.
- 3. OWNER may not connect the Property to either the sewer and water systems of the VILLAGE, except upon compliance with the following:
  - a. Connection of the OWNER'S Property to the water system of the VILLAGE, may be made in 2023 or any year thereafter. Should OWNER seek to make such a connection in 2023 and before 2041, payment shall be made pursuant to Resolution 2021-56, Amended Special Assessment Report pages 10-11, paragraph 14, in addition to any applicable impact or connection fees, which is attached hereto as **Exhibit B**.
  - b. Connection of the OWNER'S Property to the sewer system of the VILLAGE, may be made in 2023 or any year thereafter. Should OWNER seek to make such a connection in 2023 and before 2041, payment shall be made pursuant to Resolution 2021-56, Amended Special Assessment Report pages 27-28, paragraph 14, in addition to any applicable connection fees, which is attached hereto as **Exhibit C**.
  - c. Connection of the OWNER'S Property to either the water or sewer systems in 2041 or thereafter will require payment in full of the amounts set forth above.

- d. The provisions of this Agreement are covenants that run with the land and shall be binding upon and inure to the benefit of the parties to this Agreement and their respective heirs, successors and assigns.
- 4. This Agreement may be executed in one or multiple counterparts, each constituting an original, but all of which together shall constitute the complete Settlement Agreement.

This Agreement shall become effective when signed by the OWNER and by authorized representative(s) of the VILLAGE. It may be recorded in the office of the Register of Deeds for Racine County.

[Signature Pages to Follow]

Dated: 13/19/2023	Darlene Daines
	Village of Caledonia
Dated: 12-12-23	Thomas R. Weutherston Village President
Dated: 12-12-23	Wayne Kweger  By: Joslyn Hoeffert  Village Clerk, Deputy
	Caledonia Sewer and Water Utility District
Dated:	Den Hayrand Change
	By: Howard Stacey President

#### **EXHIBIT A**

- 1. OWNER property located at 13010 4 Mile Road, Franksville, WI 53126; Tax No: 51-104-04-22-19-071-000
- 2. Total assessment \$141,587.47 (\$108,330.05 for sewer and \$33,257.42 for water).